
# PROPOSED NEW CO-LIVING AT LOT 16 DP 1084067 AT 61 & 63 BRADLEY STREET GOULBURN, NSW, 2580

DWG #	REV #	TITLE OF DRAWING
A-01	A	TITLE
A-02	A	SURVEY
A-03	A	GENERAL NOTES
A-04	A	EXISTING SITE PLAN
A-05	A	DEMOLITION SITE PLAN
A-06	A	PROPOSED SITE PLAN
A-07	A	EXISTING FLOOR PLAN
A-08	A	DEMOLITION FLOOR PLAN
A-09	A	GROUND FLOOR PLAN
A-10	A	FIRST FLOOR PLAN
A-11	A	SECOND LEVEL FLOOR PLAN
A-12	A	ROOF TOP TERRACE PLAN
A-13	A	TYPICAL UNIT DETAIL - 1
A-14	A	TYPICAL ACCESSIBLE UNIT DETAIL - 2
A-15	A	TYPICAL ACCESSIBLE BATHROOM DETAILS
A-16	A	TYPICAL ACCESSIBLE BATHROOM DETAILS 2
A-17	A	TYPICAL UNIT DETAIL - 3
A-18	A	ELEVATIONS
A-19	A	ELEVATIONS
A-20	A	SECTION A-A
A-21	A	SECTION B-B
A-22	A	SECTION C-C
A-23	A	SHADOW DIAGRAMS
A-24	A	SHADOW DIAGRAMS
A-25	A	SHADOW DIAGRAMS
A-26	A	DOOR SCHEDULE
A-27	A	WINDOW SCHEDULE
A-28	A	3D CONCEPT
A-29	A	FIRE ESCAPE PLAN
A-30	A	PROPOSED LANDSCAPE PLAN

DRAWING AMENDMENTS			BRADLEY ST REDEVELOPMENT		+L TIMLEE DRAWING TITLE TITLE		DRAWING VERIFIED BY
REVISION DESCRIPTION A DEVELOPMENT APPLICATION	DATE 06/12/2024	CLIENT YARRABEE PROPERTY GROUP PTY LTD	ARCHITECTS residential commercial industrial P: 02 4822 5934 ABN: 71425067537		07/24 DRAWING SCALE	drawn by AH	
			Figured dimensions take precedence. Do not scale drawings. Builder to check all levels datum and dimensions on the job, conflicting information to be resolved by the project manager prior to commencing work. All materials and workmanship to be in restrict accordance with current Australian standards, BCA, Local regulation	ROSS PLACE GOULBURN NSW 2580 NOMINATED ARCHITECT:	LOT 16 DP 1064067	AT SHEET SIZE A3 SHEET	JOB NUMBER 0624-1688
		COPYRIGHT	and manufacturers current printed instructions. Unless noted otherwise use only best quality materials, fittings and fixtures. COPYRIGHT TIM LEE ARCHITECTS Drawings subject to copyright and may not be reproduced in any form without the written permission of the architect.	TIM LEE NSW REG: 7304 ACT REG: 1030	STREET ADDRESS 61 & 63 BRADLEY STREET GOULBURN	DRAWING IDENTIFICATION NUMBER	AMENDMENT ISSUE

\_\_ISSUED FOR\_\_\_ DEVELOPMENT APPLICATION NOT FOR CONSTRUCTION

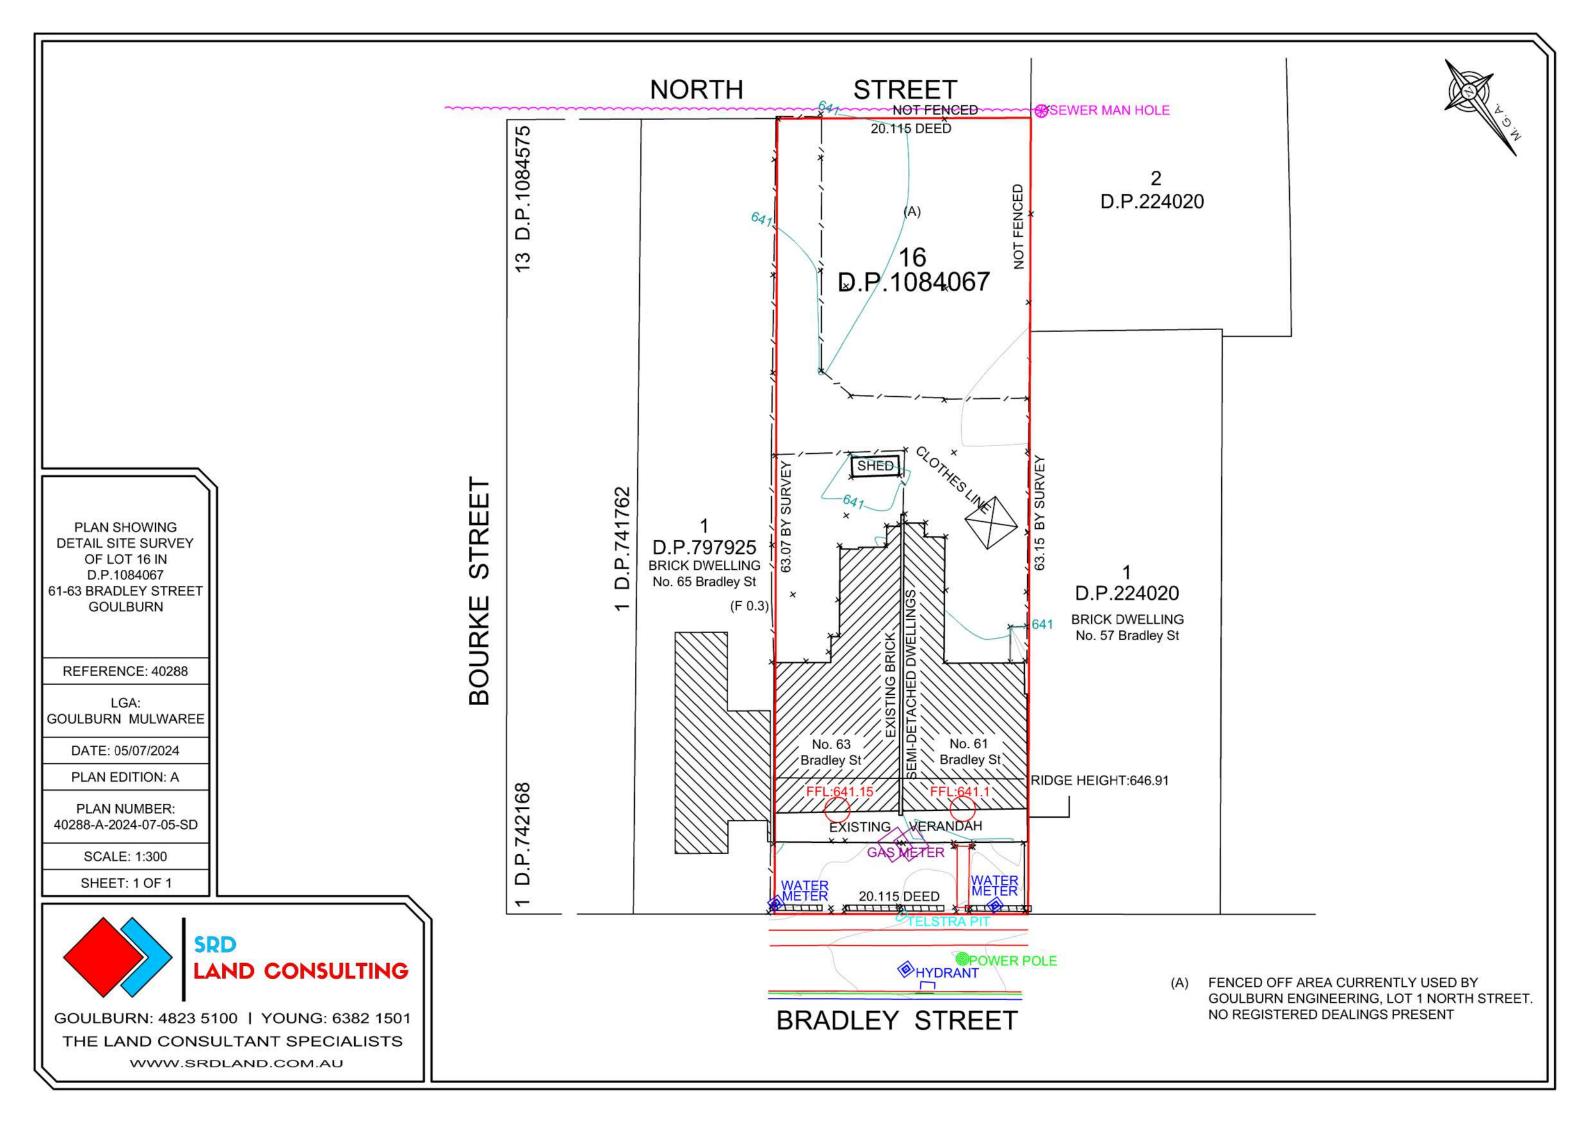

#### NCC & AUSTRALIAN STANDARDS COMPLIANCE NOTES

ALL BUILDING WORKS, SIGNAGE, FITTINGS & FIXTURES TO BE INSTALLED IN STRICT ACCORDANCE TO MEET AS1428.1. & BE INSTALLED TO MANUFACTURER'S CURRENT PRINTED INSTRUCTIONS.

CONTRACTOR TO SHOW FULL COMPLIANCE WITH ALL CURRENT REQUIRED CODES, STANDARDS, LOCAL LEGISTLATION, BY-LAWS & PARTS OF THE NCC, INCLUDING BUT NOT LIMITED TO THE FOLLOWING:

NCC VOL 1 - SECTION A	GOVERNING REQUIREMENTS
NCC VOL 1 - SECTION B	STRUCTURE
NCC VOL 1 - SECTION C	FIRE RESISTANCE
NCC VOL 1 - SECTION D	ACCESS & EGRESS
NCC VOL 1 - SECTION E	SERVICES & EQUIPMENT
NCC VOL 1 - SECTION F	HEALTH & AMENITY
NCC VOL 1 - SECTION G	ANCILLARY PROVISIONS
NCC VOL 1 - SECTION I	SPECIAL USE BUILDINGS
NCC VOL 1 - SECTION J	ENERGY EFFICIENCY
NCC VOL 1 - SCHEDULE 3	COMMONWEALTH OF AUSTRALIA
NCC VOL 1 - SCHEDULE 4	AUSTRALIAN CAPITAL TERRITORY
NCC VOL 1 - SCHEDULE 5	NEW SOUTH WALES

- VENTILATION IS REQUIRED TO ALL BUILDINGS TO MEET PART F6 OF THE NCC. AS/NZS 1170.2 :2011 STRUCTURAL DESIGN ACTIONS - WIND ACTIONS AS 1288 : 2006 GLASS IN BUILDING & NCC CLAUSE BP1.3 AS 1379 : 2007 SPECIFICATION & SUPPLY OF CONCRETE
- DESIGN & INSTALLATION OF SHEET ROOFING & WALL CLADDING AS 1562 : 2018 AS 1684.2 : 2010 TIMBER-FRAMED CONSTRUCTION - NON-CYCLONIC AREA - N1/N2 SUPPLEMENT 1: TIMBER FRAMING SPAN TABLES - WIND CLASSIFICATION N1/N2 - SEASONED SOFTWOOD - STRESS GRADE F5 (SUPPLEMENT TO AS 1684.2 : 2010)
- AS 1668.1 : 2015 THE USE OF VENTILATION & AIR CONDITIONING IN BUILDINGS. PART 1: FIRE & SMOKE CONTROL IN BUILDINGS
- AS 1668.2 : 2012 THE USE OF VENTILATION & AIR-CONDITIONING IN BUILDINGS, PART 2: MECHANICAL VENTILATION IN BUILDINGS
- AS 2047 : 2014 GLAZING ASSEMBLIES & NCC BP1.3 & F1.13
- AS 2436 : 2010 GUIDE TO NOISE & VIBRATION CONTROL ON CONSTRUCTION, **DEMOLITION & MAINTENANCE SITES**
- AS/NZS 2589 : 2017 GYPSUM LININGS - APPLICATIONS & FINISING
- AS/NZS 2904 : 1995 DAMP-PROOF COURSES & FLASHINGS
- AS/NZS 3000 : 2018 ELECTRICAL INSTALLATIONS / WIRING
- AS/NZS 3008 · 2017 FLECTRICAL INSTALLATIONS
- AS/NZS 3012 : 2010 **ELECTRICAL INSTALLATIONS - CONSTRUCTION & DEMOLITION** SITES
- AS/NZS 3500.3 : 2015 PLUMBING & DRAINAGE - STORMWATE DRAINAGE AS 3600 : 2018 CONCRETE STRUCTURES
- AS 3610 1 · 2018 FORMWORK FOR CONCRETE SPECIFICATIONS
- AS 3660.1 : 2014 TERMITE MANAGEMENT PART 1: NEW BUILDING WORK
- TERMITE MANAGEMENT PART 2 : IN & AROUND EXISTING AS 3660.2 : 2017 **BUILDINGS & STRUCTURES** AS 3666 1 · 2011 AIR HANDLING & WATER SYSTEMS OF BUILDING MICROBIAL
- CONTROL AS 3700 : 2018 MASONRY STRUCTURES

AS 4349 : 2007

AS 3740 : 2021 WATERPROOFING OF DOMESTIC WET AREAS & NCC PART F1.7 AS 3786 : 2014 SMOKE ALARMS USING SCATTERED LIGHT, TRANSMITTED LIGHT OR IONIZATION

INSPECTION OF BUILDINGS

#### NCC & AUSTRALIAN STANDARDS COMPLIANCE NOTES

AS/NZS 4654 : 2012	WATERPROOFING MEMBRANES FOR EXTERNAL ABOVE- GROUND USE				
AS 4647 : 2004	DESIGN, CONSTRUCTION & FIT-OUT OF FOOD PREMISES				
AS/NZS 4671 : 2019	STEEL FOR THE REINFORCEMENT OF CONCRETE				
AS 5104 : 2017	GENERAL PRINCIPLES ON RELIABILITY FOR STRUCTURES				
SCHEDULE OF FIRE SAFETY MEASURES           EMERGENCY LIGHTING         NCC PART E4D2, E4D4 AS 2293.1           FIRE HYDRANTS         NCC PART E1D2, AS 2419.1           FIRE HYDRANTS         NCC PART E1D3, AS 2441           EXIT SIGNS         NCC PART E4D5, E4D6, E4D8, AS/NZS 2293.1           PORTABLE FIRE EXTINGUISHERS         NCC PART E1D14, AS 2444           FIRE BLANKETS         NCC PART E1D14, AS 2444           FIRE BLANKETS         NCC PART E1D14, AS 2444           EXIT DOORS         NCC PART E1D14, AS 2444					
	N HAS BEEN ASSUMED, FINAL SET OUT, SITE LEVELS, ELS, ETC, TO BE CONFIRMED ONSITE BY SURVEYOR PRIOR TO				

COMMENCING WORKS

CONTRACTOR TO "DIAL BEFORE YOU DIG" BEFORE ANY WORKS ARE CARRIED OUT.

INGRESS TO AND EGRESS FROM THE SITE, CAR PARKING AND ACCESS, DRIVEWAYS WIDTHS, TURNING CIRCLES AND THE DIMENSIONS OF ALL LOADING BAYS MUST BE DESIGNED IN ACCORDANCE WITH : AS/NZS 2890.1:2004, PARKING FACILITIES, PART 1: OFF-STREET CAR PARKING

- AS 2890.2:2018, PARKING FACILITIES, PART 2 : OFF-STREET COMMERCIAL VEHICLE FACILITIES - AS 2890.3:2015, PARKING FACILITIES, PART 3 : BICYCLE PARKING - AS 2890.5:2020, PARKING FACILITIES, PART 5 : ON-STREET PARKING - AS 2890.6:2009, PARKING FACILITIES, PART 6: OFF-STREET PARKING FOR PEOPLE WITH DISABILITIES RMS AUSTRALIAN STANDARD SUPPLEMENTS

GUIDE TO TRAFFIC GENERATING DEVELOPMENTS, VERSION 2.2 BY RTA OCT 2002 - GOULBURN MULWAREE COUNCIL DCP OR LOCAL COUNCIL DCP

### ASBESTOS REMOVAL COMPLIANCE NOTES (IF FOUND):

IF & WHEN ASBESTOS IS FOUND, WORK IS TO STOP IMMEDIATELY & A LICENSED ASBESTOS REMOVALIST IS TO BE ENGAGED TO REMOVE THE ASBESTOS.

THE ASSESSMENT, REMOVAL & DISPOSAL OF ASBESTOS TO MEET ALL AUSTRALIAN STANDARDS, NCC (BCA) REQUIREMENTS & "HOW TO SAFELY REMOVE ASBESTOS - CODE OF PRACTICE" APRIL 2016 BY SAFE WORK AUSTRALIA, APPROVED CODE OF PRACTIVE UNDER SECTION 274 OF THE "WORK HEALTH & SAFETY ACT" (THE WHS ACT) & THE "WORK HEALTH & SAFETY REGULATIONS" (THE WHS REGULATIONS)

THE REMOVAL OF ASBESTOS IS TO BE ACCESSED & CARRIED OUT BY A LICENSED ASBESTOS REMOVALIST WHO IS APPROPRIATELY LICENSED TO CARRY OUT THE SCOPE OF WORKS

THE LICENSED ASBESTOS REMOVALIST MUST PREPARE AN ASBESTOS REMOVAL CONTROL PLAN FOR ANY LICENSED ASBESTOS REMOVAL WORK THEY ARE COMMISSIONED TO CARRY OUT. THE ASBESTOS REMOVAL CONTROL PLAN TO BE PREPARED PRIOR TO COMMENCEMENT OF WORKS

DURING THE REMOVAL & DISPOSAL OF THE ASBESTOS, THE LICENSED ASBESTOS REMOVALIST IS TO ENSURE DECONTAMINATION FACILITIES, WASTE CONTAINMENT & DISPOSAL METHODS MEET THE ABOVE-MENTIONED RULES & REGULATIONS.

IF ASBESTOS CONTAMINATED SOIL IS DISCOVERED DURING WORKS & EXCAVATION ONSITE ALL WORK IS TO CEASE IMMEDIATELY. THE LICENSED ASBESTOS REMOVALIST IS TO BE CONTACTED IMMEDIATELY & AWAIT THEIR INSTRUCTIONS.

#### COMPLIANCE NOTES:

ALL LEVELS SHOWN ARE BASED ON SUPPLIED 3rd PARTY SURVEY INFORMATION. TIM LEE ARCHITECTS ACCEPTS NO RESPONSIBILITY OR INDEMNITY FOR THE ACCURACY OF SUPPLIED SITE INFORMATION. IT IS THE CONTRACTOR'S RESPONSIBILITY TO CONFIRM ALL LEVELS ON SITE PRIOR TO COMMENCING ANY EXCAVATION OR SITE WORKS. TIM LEE ARCHITECTS TO BE NOTIFIED OF ANY ANOMALIES PRIOR TO THE CONTRACTOR STARTING ANY WORKS

REGISTERED SURVEYOR TO ESTABLISH BOUNDARY & SET OUT BUILDING IN STRICT ACCORDANCE WITH THIS DOCUMENTATION SET. ALL DIMENSIONS SUBJECT TO SITE SURVEY

### COMPLIANCE NOTES:

SUPPLY & INSTALL ALL NECESSARY FITTINGS & FIXTURES IN STRICT ACCORDANCE WITH MANUFACTURER'S CURRENT PRINTED INSTRUCTIONS.

ALL FLOOR LEVELS & GROUND LEVELS ARE ASSUMED & ARE TO BE CONFIRMED ONSITE, PRIOR TO COMMENCING ANY WORKS

IT IS THE RESPONSIBILITY OF THE CONTRACTOR AND SUB-CONTRACTORS TO MAKE THEMSELVES FULLY AWARE OF CONDITIONS WHICH WILL AFFECT THE EXECUTION OF THE WORKS

THE CONTRACTOR IS TO ENSURE COMPLETE COMPLIANCE WITH ALL RELEVANT NCC CODES, AUSTRALIAN STANDARDS AND LOCAL REGULATIONS AND BY-LAWS AS REQUIRED.

ALL MATERIALS & WORKMANSHIP ARE TO BE IN STRICT ACCORDANCE WITH THE MANUFACTURER'S CURRENT PRINTED INSTRUCTIONS.

ALL MATERIALS & WORKMANSHIP ARE TO BE OF BEST QUALITY UNDERTAKEN BY FULLY QUALIFIED TRADESMEN. ALL MATERIALS TO BE SUPPLIED NEW. ALL DAMAGED MATERIALS TO BE REJECTED AND REPLACED WITH NEW

IF ALTERNATIVE MATERIAL OR PRODUCT IS PROPOSED TO THAT SPECIFIED, THE BUILDER MUST PROVIDE EVIDENCE SHOWING COMPLIANCE WITH THE BCA AND ALL RELEVANT STANDARDS RELATING TO THE APPLICATION OF THE PROPOSED MATERIAL FURTHER THE ARCHITECT ACCEPTS NO LIABILITY OR INDEMNITY FOR THE SUBSTITUTION OF A MATERIAL CONTRARY TO THAT SPECIFIED BY THE ARCHITECT WITHOUT THE PROVISION OF WRITTEN DOCUMENTATION SHOWING COMPLIANCE WITH THE BCA AND AUSTRALIAN STANDARDS AND THE EXPRESS WRITTEN APPROVAL OF THE ARCHITECT

THE CONTRACTOR IS TO NOTIFY THE PROJECT MANAGER OF ANY ERRORS OR OMISSIONS IN THE DOCUMENTATION PRIOR TO COMMENCING WORK. THE PROJECT MANAGER TO CONTACT THE APPROPRIATE CONSULTANT FOR ADVICE PRIOR TO COMMENCING THE WORKS

COMMENCEMENT OF THE WORKS BY THE CONTRACTOR CONSTITUTES A FULL UNDERSTANDING OF THE PROJECT & ACCEPTANCE OF ALL SITE CONDITIONS & THE SUPPLIED DOCUMENTATION.

TIM LEE ARCHITECTS ACCEPTS NO RESPONSIBILITY OR INDEMNITY FOR CONDITIONS, LATENT OR OTHERWISE, ARISING WITHOUT NOTIFICATION PRIOR TO COMMENCING THE WORKS

ALL WORK TO BE CARRIED OUT BY COMPETENT, SKILLED & QUALIFIED TRADESPEOPLE HOLDING CURRENT CERTIFICATION WITH THE REQUIRED AUTHORITY.

PROVIDE ALL MATERIALS, LABOUR & EQUIPMENT NECESSARY TO COMPLETE THE WORK AS PER THE DRAWING SET & ASSOCIATED DOCUMENTATION.

GRADE FINISHED GROUND LINE TO GIVE FALLS AWAY FROM BUILDINGS

TERMITE CONTROL TO ALL AREAS AS REQUIRED BY AS 3660.1 & 3660.2.

INSTALL HARD WIRED SMOKE ALARMS TO AS 3786.

ALL WALLS TO BE WRAPPED IN ENVIROSEAL COMMERCIAL WALL WRAP. ALL JOINTS TO BE LAPPED MIN. 300mm AND TAPED. FIX TO MANUFACTURER'S CURRENT PRINTED INSTRUCTIONS

RANGE HOODS EXHAUST SYSTEMS TO HAVE A MINIMUM FLOW RATE OF KITCHENS 5 LS/m<sup>2</sup> & CHANGEROOMS 5 LS/m<sup>2</sup> TO AS 4674 & AS 1668.2.

EXHAUSTS FROM BATHROOMS & LAUNDRY MUST BE DISCHARGED DIRECTLY OR VIA A SHAFT OR DUCT TO OUTSIDE AIR. INSTALL TO MANUFACTURER'S CURRENT PRINTED INSTRUCTIONS. REFER TO MECHANICAL DETAILS.

MECHANICAL VENTILATION & LIGHTING TO MEET NCC PART F4.

ONCE WINDOWS ARE INSTALLED. CONTRACTOR TO SEAL WINDOW PERIMETERS WITH EXPANDING FOAM FILLER FIRE RETARDANT TO GIVE FULLY AIR-TIGHT SEAL AGAINST FRAME. INSTALL TO MANUFACTURER'S CURRENT PRINTED INSTRUCTIONS.

A JAS-ANZ ACCREDITED 3RD PARTY PROCESSOR CERTIFICATE (ACRS OR FOULIVALENT) MUST BE SUPPLIED WITH ALL STEEL REINFORCEMENT AT PROCLIREMENT BEFORE ANY CONCRETE IS PLACED TO GUARANTEE CONFORMANCE OF THE REINFORCEMENT TO AS/NZS 4671.

CLADDING TO BE INSTALLED IN ACCORDANCE WITH MANUFACTURER'S CURRENT PRINTED INSTRUCTIONS. INSTALL OVER ENVIROSEAL COMMERCIAL WALL WRAP. LAP & TAPE ALL JOINTS & FRAME PENETRATIONS TO ENSURE AN AIRTIGHT BUILDING SEAL.

		DATE	BRADLEY ST REDEVELOPMENT	EY ST REDEVELOPMENT +L TIM LEE		GENERAL NOTES	DRAWING COMMENCED	drawing verified by T.L.
REVISION DESCRIPTION A DEVELOPMENT APPLICATION		DATE 06/12/2024	YARRABEE PROPERTY GROUP PTY LTD	P: 02 4822 5934 ABN: 71425067537	LOT AND DEPOSITED PLAN NO.	LOT 16 DP 1084067	drawing scale 1:100	drawn by
		Builder to check all levels datum and dimensions on	Figured dimensions take precedence. Do not scale drawings. Builder to check all levels datum and dimensions on the job, conflicting information to be resolved by the project manager prior to commencing work. All materials and workmanship to be in restrict accordance with current Australian standards, BCA, Local regulation	ROSS PLACE GOULBURN NSW 2580 NOMINATED ARCHITECT:			AT SHEET SIZE A3 SHEET	JOB NUMBER 0624-1688
			and manufacturers current printed instructions. Unless noted otherwise use only best quality materials, fittings and fixtures. COPYRIGHT TIM LEE ARCHITECTS Drawings subject to copyright and may not be reproduced in any form without the written permission of the architect.	TIM LEE NSW REG: 7304 ACT REG: 1030	STREET ADDRESS	61 & 63 BRADLEY STREET GOULBURN	DRAWING IDENTIFICATION NUMBER	AMENDMENT ISSUE

### COMPLIANCE NOTES:

SITE PREPARATION SHALL BE CARRIED OUT IN ACCORDANCE WITH ENGINEER'S DETAILS.

LIFT OFF HINGES TO ALL WC COMPARTMENT DOORS WHERE OPENING INWARDS.

ALL FIRST FLOOR WINDOWS TO HAVE A CHILD RESTRICTIVE OPENING DEVICE TO PREVENT THEM OPENING MORE THAN 120mm TO MEET NCC D2.24. INSTALL TO MANUFACTURER'S CURRENT PRINTED INSTRUCTIONS.

ALL PAINT FINISHES (EXTERNAL AND INTERNAL) TO BE LEVEL 4 PAINT FINISH (MIN. 4 COATS), SEAL COAT, UNDERCOAT, 2 x TOP COATS.

ALL PLASTERING TO A MINIMUM LEVEL 4 FINISH. ALL PLASTER FINISH WHERE USING SATIN & LOW SHEEN PAINTING FINISH TO BE A LEVEL 4 FINISH. ALL PLASTER PAINTING WHERE USING GLOSS OR SEMI GLOSS PAINTING FINISH TO BE A LEVEL 5 FINISH

ALL EXTERNALLY LOCATED MANUFACTURERED TIMBER PRODUCTS PROTECTED IN ACCORDANCE WITH MANUFACTURER'S CURRENT PRINTED INSTRUCTIONS.

# WET AREAS COMPLIANCE NOTES

WET AREAS SHOWN HATCHED LAY NON-SUP CERAMIC THES TO FOLIAL B11 / P4 SUP RATING ON MORTAR BED GRADED TO GIVE FALLS TO FW'S AS SHOWN. AREAS TO BE TREATED IN ACCORDANCE WITH AS 3740.

THE WATERPROOFING SYSTEM TO BE APPROPRIATE FOR THE BASE CONSTRUCTION. DO NOT WATERPROOF OVER PARTICLEBOARD OR TIMBER FLOORING.

PROVIDE EVIDENCE OF MANUFACTURER'S PRODUCT INSTALLATION DATA SHEETS & REQUIREMENTS REQUIREMENTS FOR ALL WATERPROOFING SYSTEMS.

INSTALL ALL PRODUCTS TO MANUFACTURER'S CURRENT PRINTED INSTRUCTIONS.

### TILING COMPLIANCE NOTES

TILING TO BE COMPLETED WITH NO RAISED EDGES OR TIGHT JOINTS.

APPROPRIATE TRIMS & FINISH BEADS TO BE INSTALLED.

SUB-STANDARD TILING WILL BE REJECTED. REJECTED WORK TO BE REMOVED. BASE WORK IS TO BE REPREPARED & NEW MATCHING MATERIALS SUPPLIED & LAID AT CONTRACTOR'S EXPENSE.

### FOOD PREMISES DESIGNED & INSTALLED TO MEET:

### FOOD SAFETY STANDARDS

- 3.1.1 INTERPRETATIONS & APPLICATION - 3.2.1 FOOD SAFETY PROGRAMS

- 3.2.2 FOOD SAFETY PRACTICES & GENERAL REQUIREMENTS

- 3.2.3 FOOD PREMISES & EQUIPMENT

- 3.3.1 FOOD SAFETY PROGRAMS FOR FOOD SERVICE TO VUNERABLE PERSONS AS4674-2004 DESIGN, CONSTRUCTION & FIT-OUT OF FOOD PREMISES

- FOOD ACT 2003, AS1428.1. & NCC - GMC - FOOD PREMISES DESIGN, CONSTRUCTION & FIT-OUT GUIDE

**CANTEEN FITOUT NOTES :** 

CONTRACTOR TO HAVE MANUFACTURER'S REPRESENTATIVE ONSITE PRIOR TO SUBMISSION OF PROPOSED DESIGN, TO VERIFY EQUIPMENT CHOICE & PROPOSED INSTALLATION.

CONTRACTOR TO HAVE MANUFACTURER'S REPRESENTATIVE CERTIFY ALL INSTALLATIONS

CONTRACTOR TO PROVIDE 3No. MAINTENANCE MANUALS CONTAINING ALL RELEVANT LITERATURE, COPIES OF ALL CERTIFICATES, WARRENTIES & APPROVALS RELATING TO THE WORKS


ALL DESIGN WORK & SHOP DRAWINGS TO BE SUBMITTED TO THE ARCHITECT & TO RELEVANT LOCAL AUTHORITIES PRIOR TO COMMENCING ANY WORKS.

ALL EQUIPMENT, FITTINGS & FIXTURES TO BE INSTALLED BY THE CONTRACTOR ARE TO BE INSTALLED TO MANUFACTURER'S CURRENT PRINTED INSTRUCTIONS, FULLY COMMISSIONED & CONNECTED TO ALL RELEVANT SERVICES.

CONTRACTOR TO BE TO PROVIDE 3No. SETS OF AS CONSTRUCTED DRAWINGS.


ANTI-ROTATION PINS TO ALI
TAPWARE & FITTINGS.

ISSUED FOR
DEVELOPMENT APPLICATION
NOT FOR CONSTRUCTION

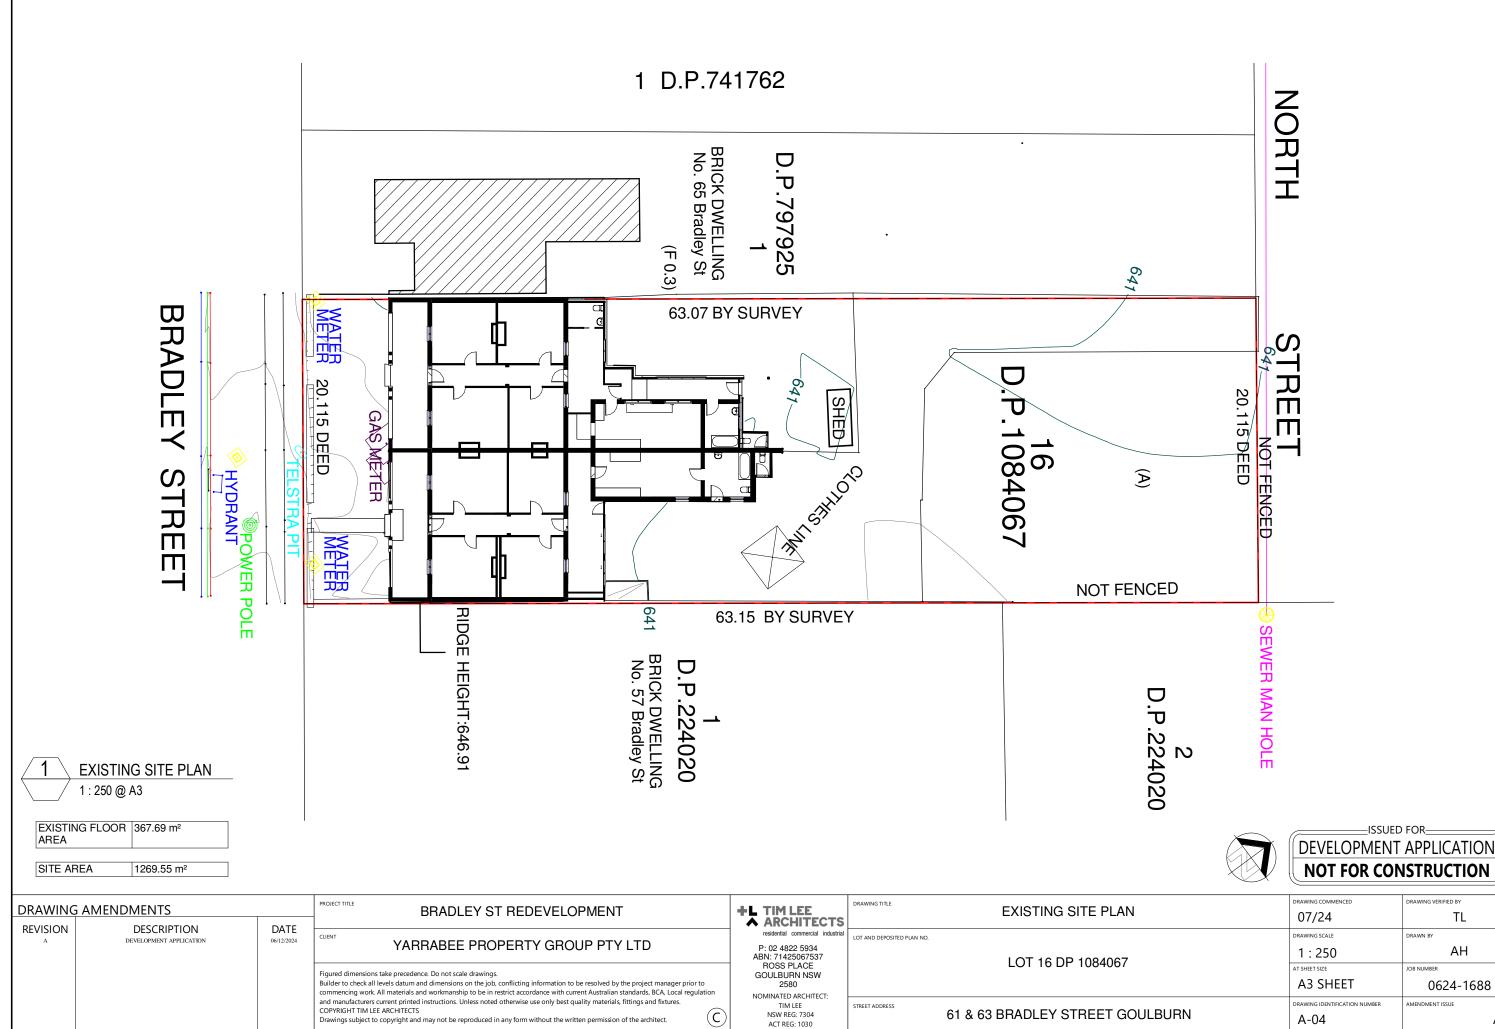

ΤL AH

MENDMENT ISSUE

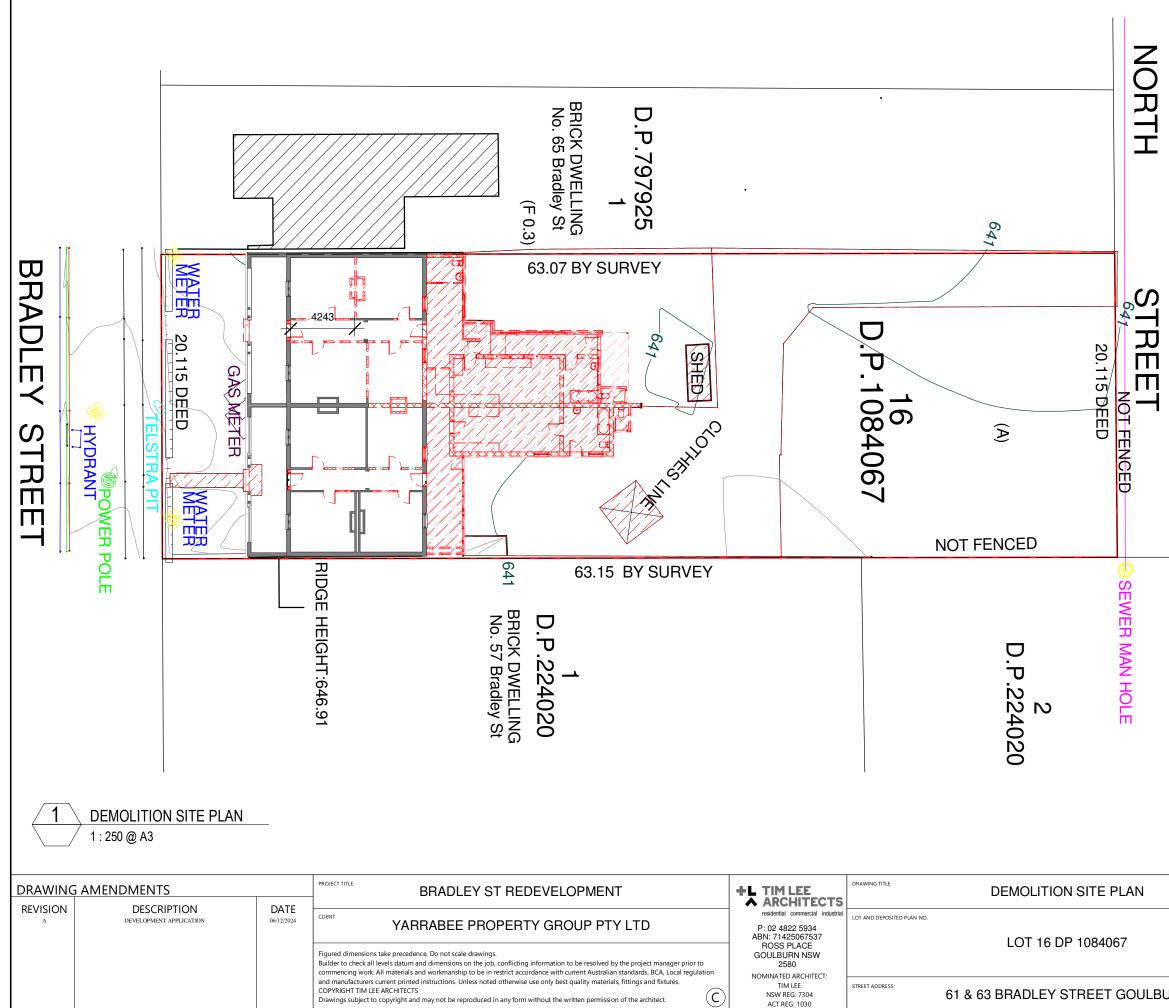



EXISTING

DEMOLISHED

PROPOSED


# DEMOLITION:


- ANY DAMAGE RESULTING FROM THE WORKS MUST BE IMMEDIATELY RECTIFIED BY THE CONTRACTOR AT THEIR OWN EXPENSE.
- DEMOLITION SHALL BE CARRIED OUT SO AS TO CAUSE NO DISTURBANCE TO SURROUNDING STRUCTURES. CARE TO BE TAKEN BELOW SLAB LEVEL.
- CARE TO BE TAKEN BELOW SLAB LEVEL. - LOCATE AND PREVENT ANY DAMAGE TO EXISTING SERVICES. IMMEDIATELY RECTIFY ANY DAMAGE OR INTERFERENCE TO THESE SERVICES AND PROVIDE TEMPORARY SERVICES WHILE REPAIRS ARE BEING CARRIED OUT.
- ALL NECESSARY PRECAUTIONS SHALL BE TAKEN TO PREVENT DAMAGE TO ALL ADJACENT WORK. SHOULD ANY DAMAGE OCCUR, THE CONTRACTOR SHALL MAKE GOOD TO THE STANDARD OF THE ORIGINAL
- IF AND WHEN OPENING UP ANY WORK, ANY CONDITIONS ARE FOUND TO BE UNSOUND OR UNSAFE THE CONTRACTOR SHALL STOP WORK AND NOTIFY THE ARCHITECT FOR THEIR INSTRUCTIONS.
- PEG AND LABEL ALL CUT / REDUNDANT SERVICES FOR LATER IDENTIFICATION.
- PROVIDE AS CONSTRUCTED DRAWINGS INDICATING LOCATION OF ALL SERVICES.
- THE CONTRACTOR SHALL REMOVE FROM SITE ALL DEBRIS AND ASSOCIATED WASTE.
- ONCE DEMOLITION'S ARE COMPLETED AND PHOTOGRAPHIC RECORDS TAKEN THE CONTRACTOR SHALL PREPARE AREAS FOR NEW WORK.
- CONTRACTOR TO REFER TO SPECIFICATION FOR ITEMS TO BE SALVAGED.



ISSUED FOR DEVELOPMENT APPLICATION NOT FOR CONSTRUCTION


	DRAWING COMMENCED	DRAWING VERIFIED BY
	07/24	TL
	DRAWING SCALE	DRAWN BY
	As indicated	AH
	AT SHEET SIZE	JOB NUMBER
	A3 SHEET	0624-1688
	DRAWING IDENTIFICATION NUMBER	AMENDMENT ISSUE
IRN	A-05	А

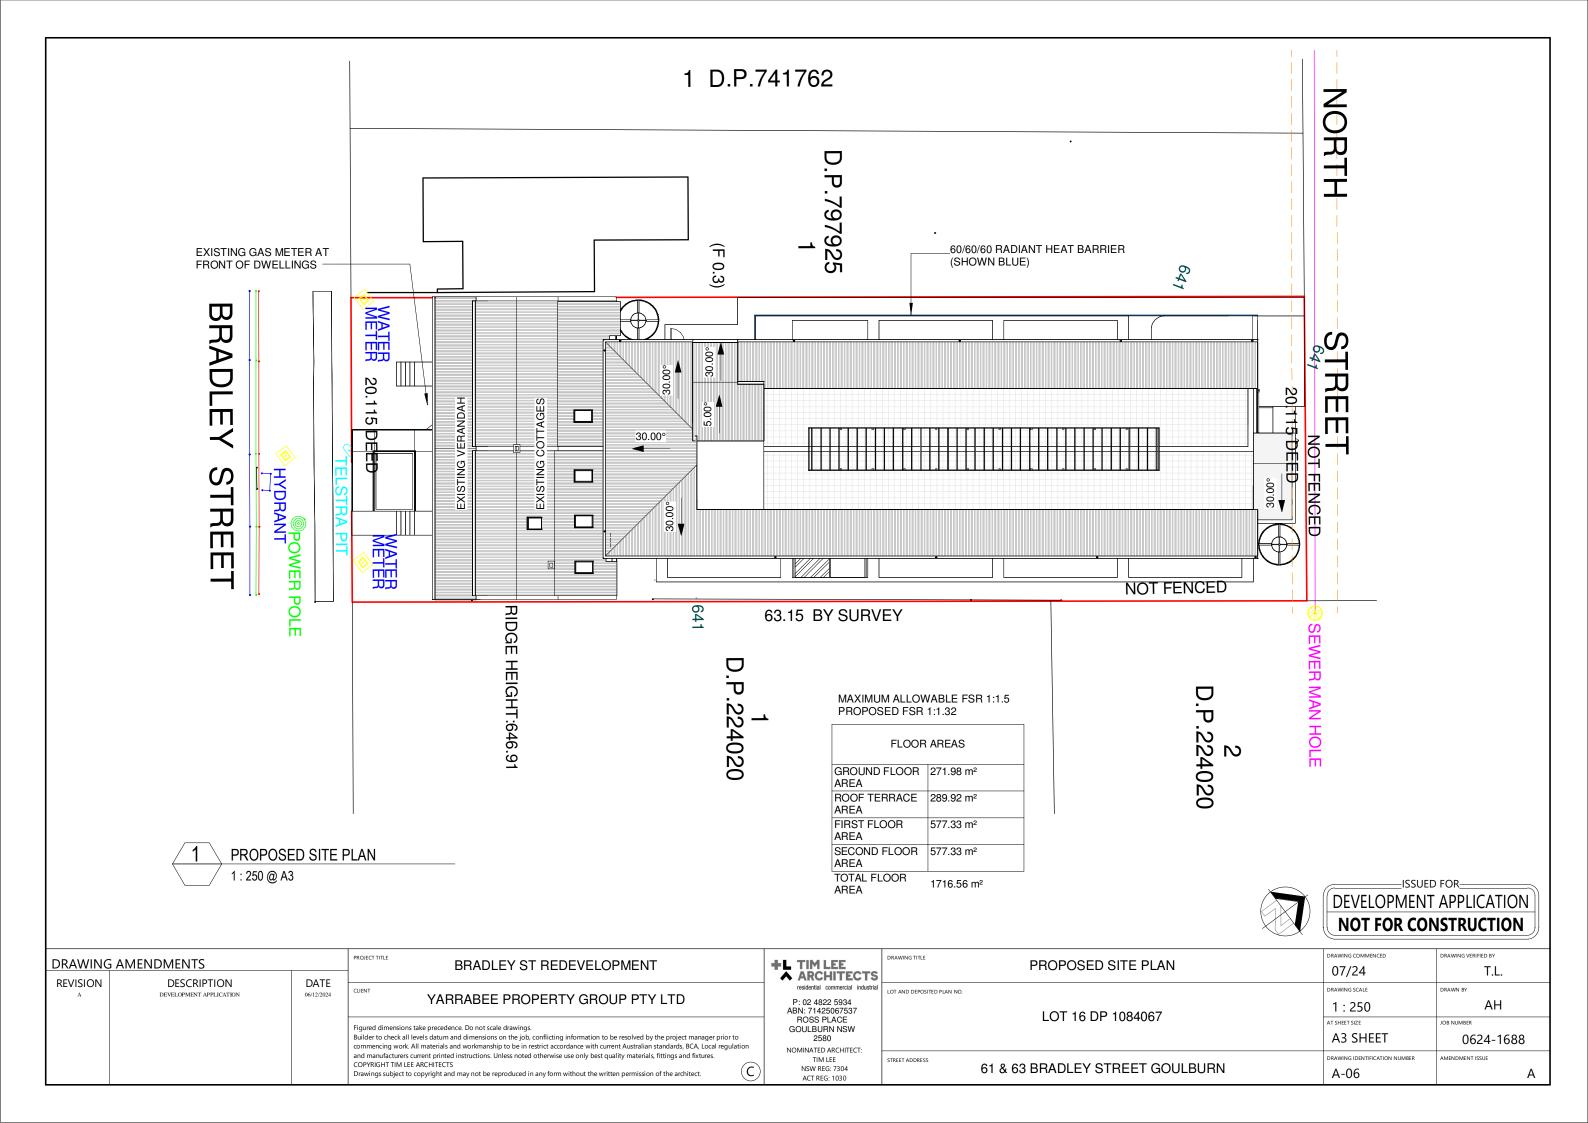

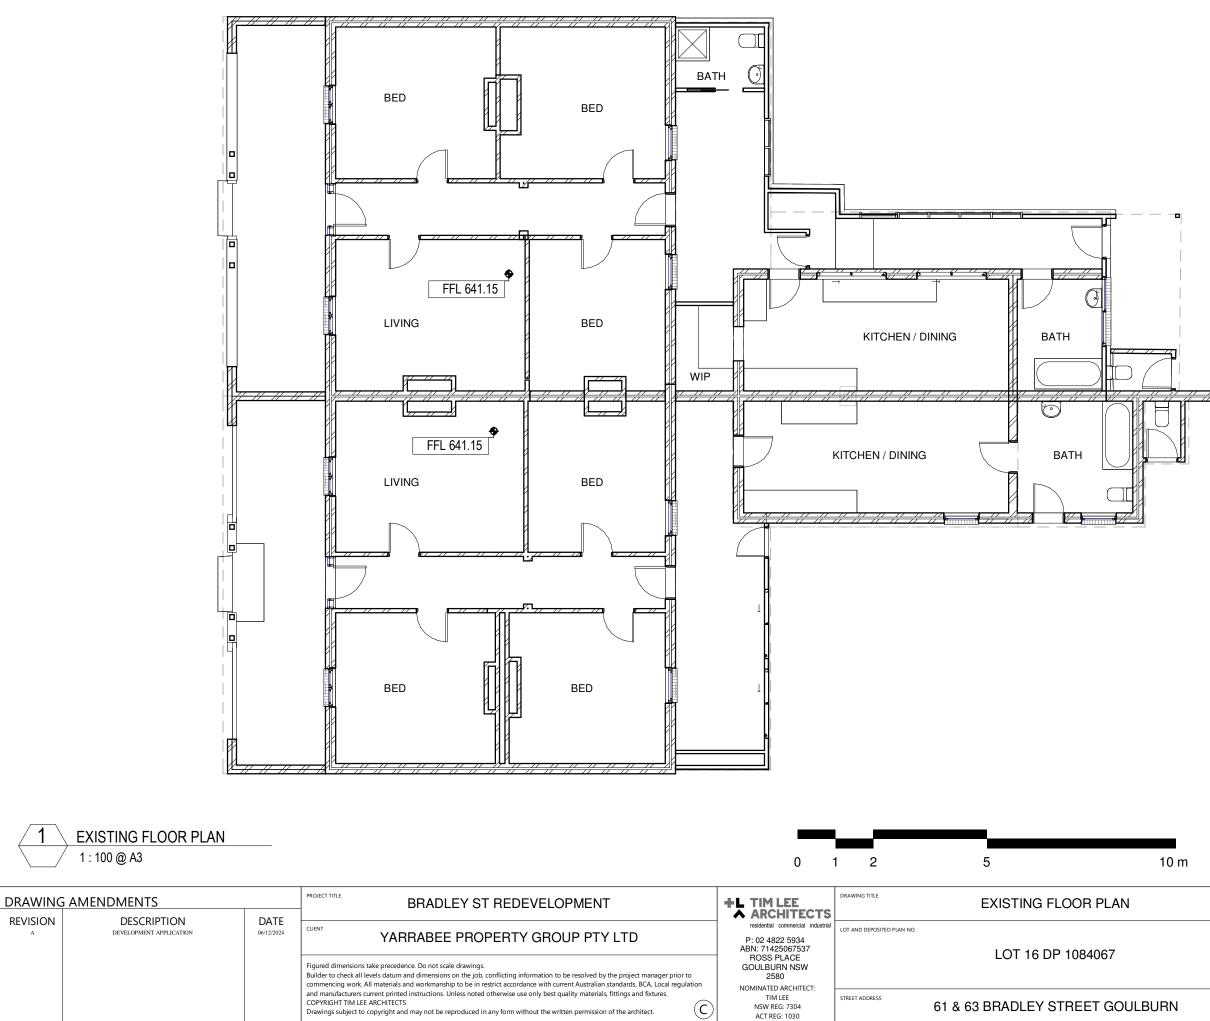



10 m	DEVELOPMENT	
	DRAWING COMMENCED	DRAWING VERIFIED BY
	07/24	TL
	DRAWING SCALE	DRAWN BY
	1 : 100	AH
	AT SHEET SIZE	JOB NUMBER
	A3 SHEET	0624-1688
	DRAWING IDENTIFICATION NUMBER	AMENDMENT ISSUE
URN	A-07	А


-ISSUED FOR-

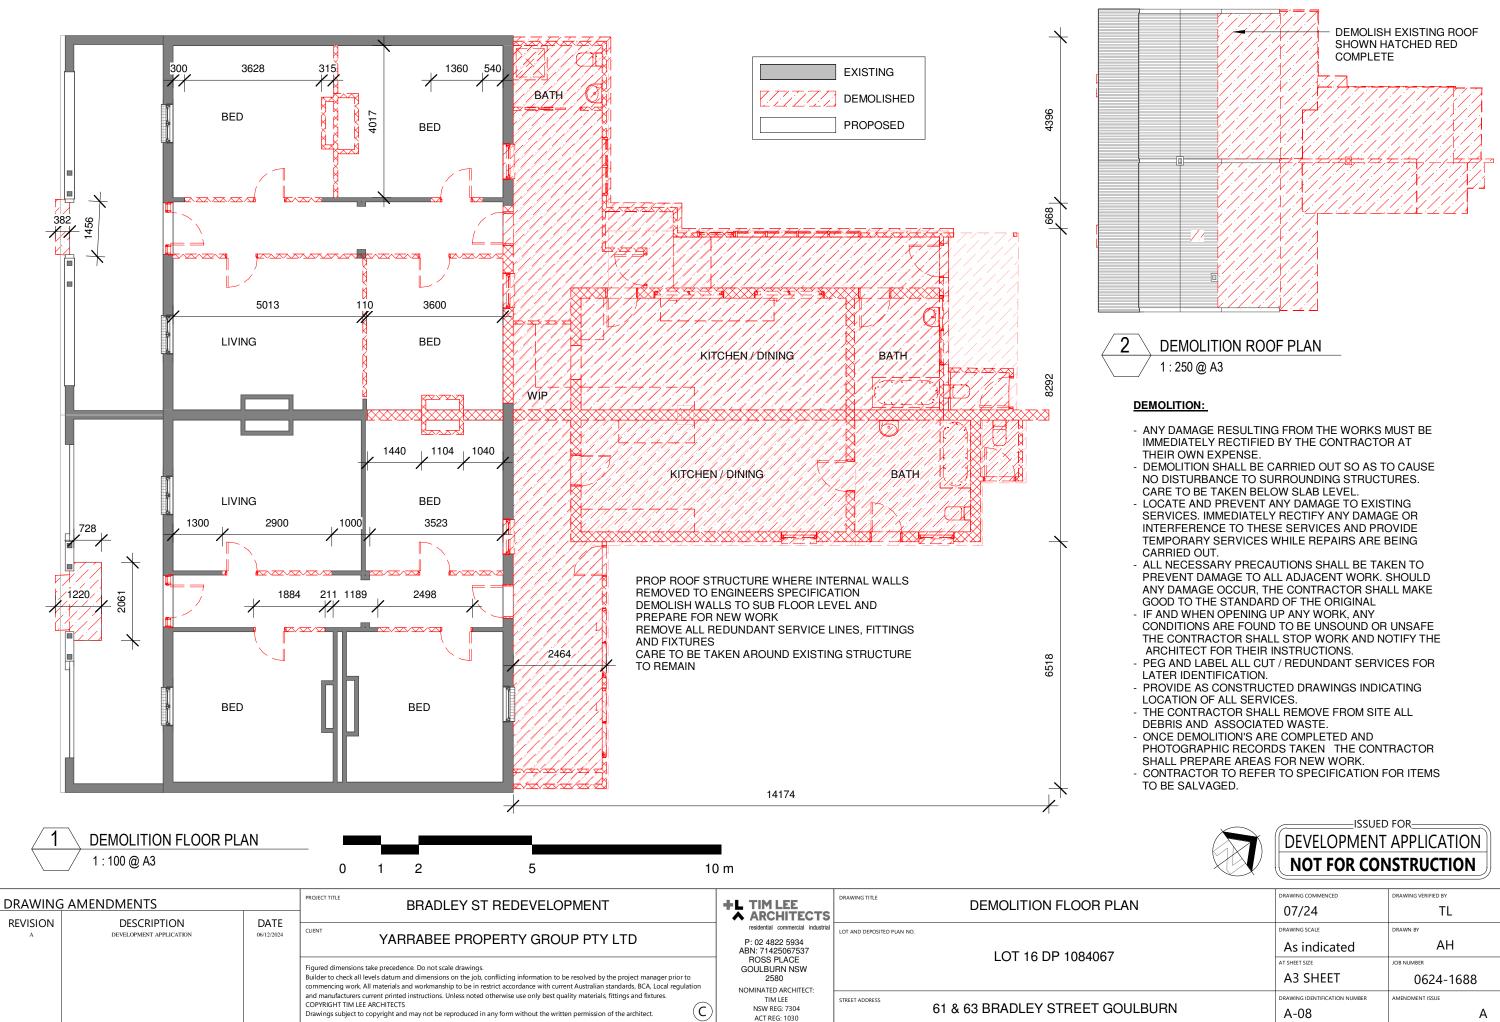


DEVELOPMENT	APPLICATION
DRAWING COMMENCED	DRAWING VERIFIED BY
07/24	TL
DRAWING SCALE	DRAWN BY
As indicated	AH
AT SHEET SIZE	JOB NUMBER
	0024 1000

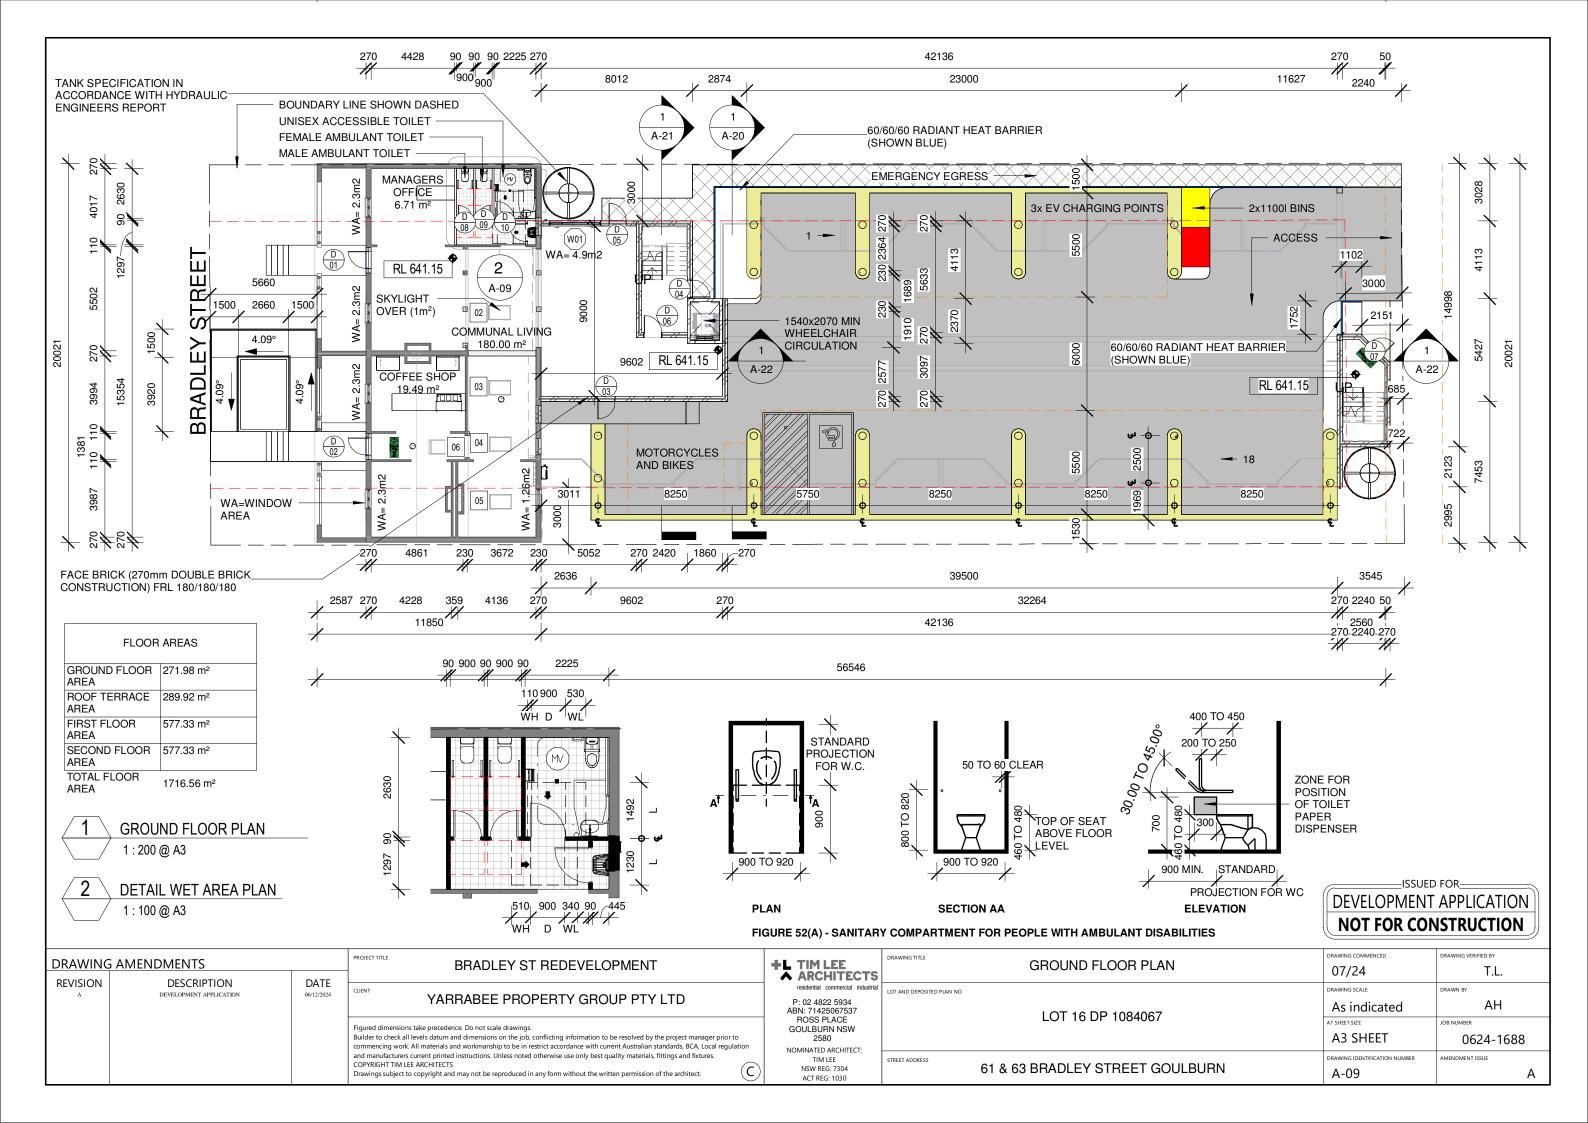

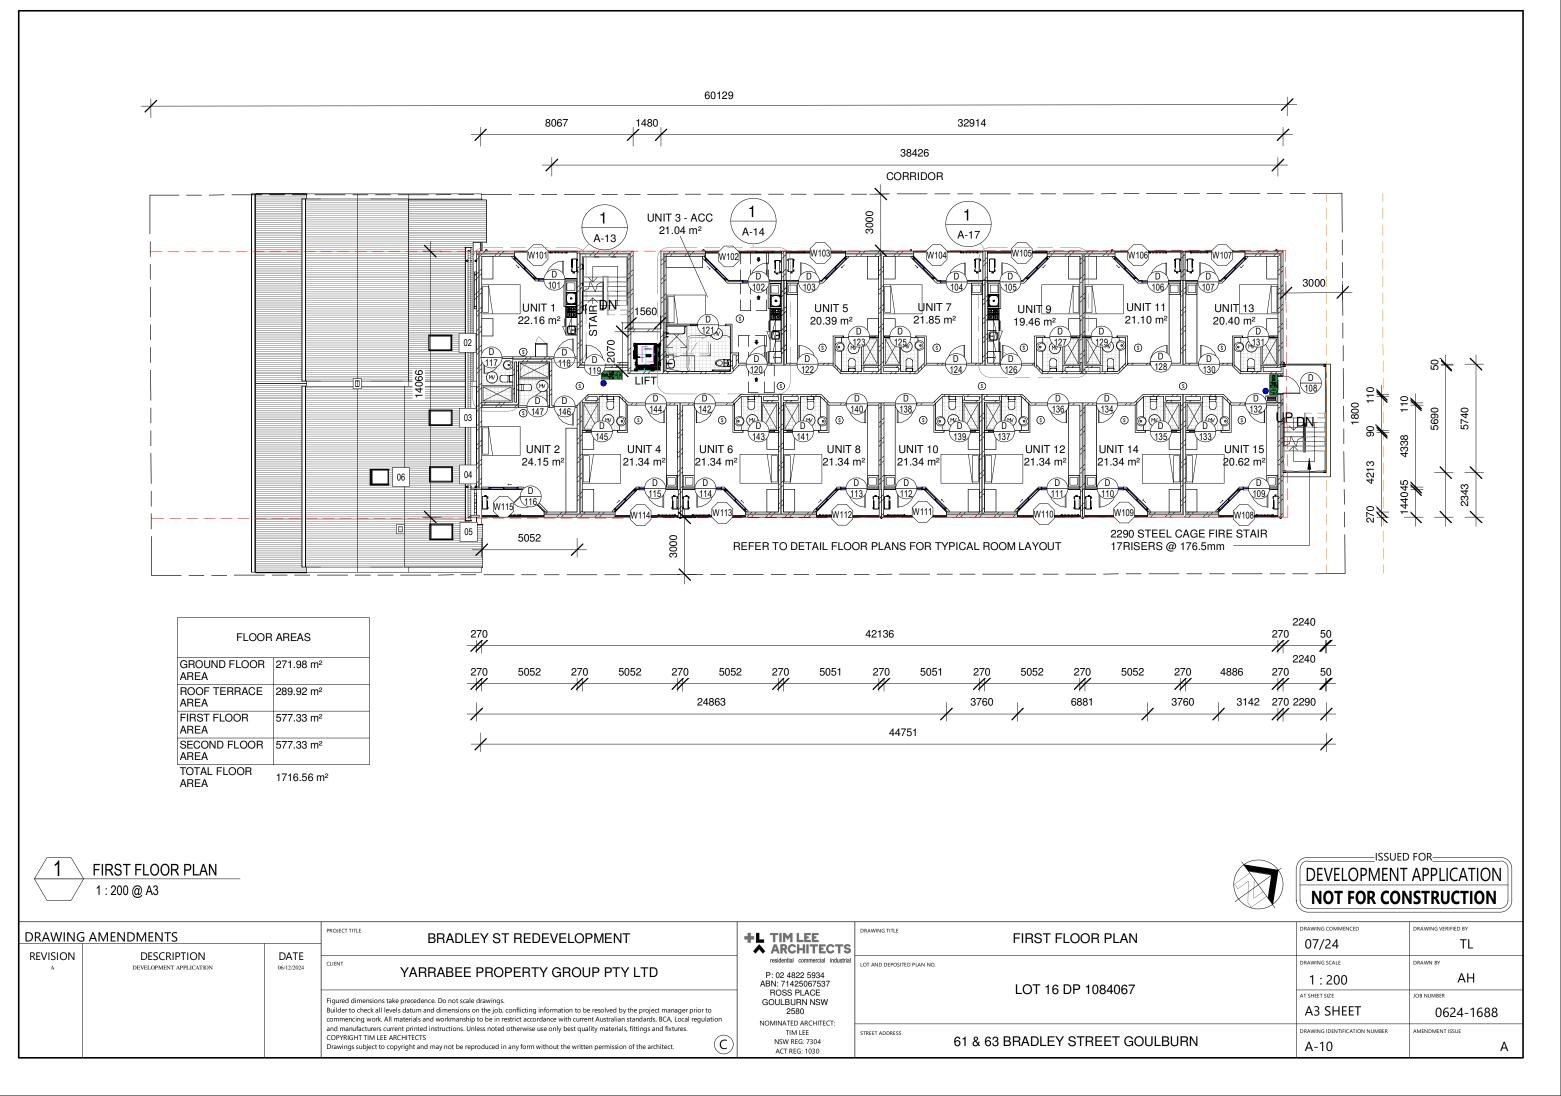

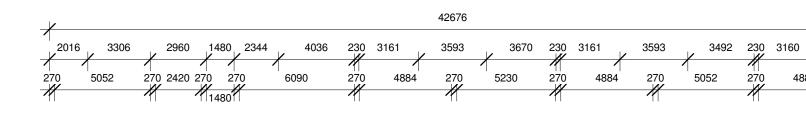

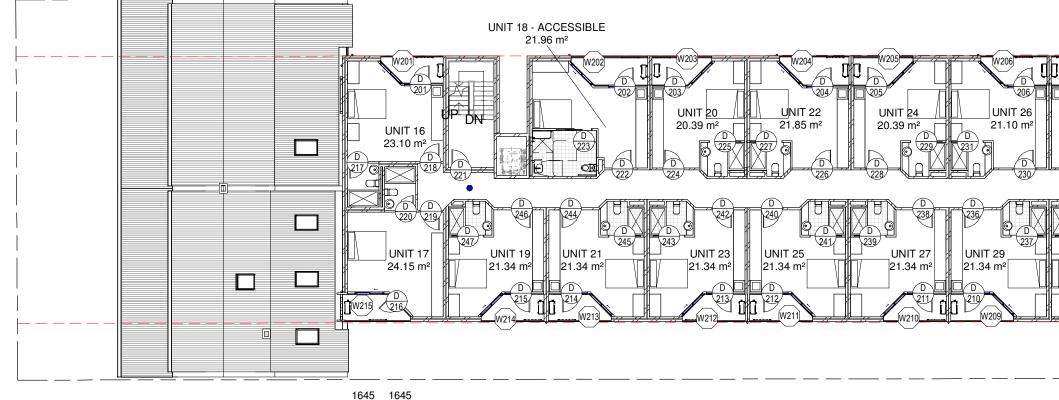


AREAS
271.98 m <sup>2</sup>
289.92 m <sup>2</sup>
577.33 m <sup>2</sup>
577.33 m <sup>2</sup>
1716.56 m <sup>2</sup>

#### 1645 1645 56 310 110 38426 270 270 5052 270 270 270 5052 270 5052 5051 5051 5052 270 5052 $-\mathcal{H}$ X X X X

 SECOND FLOOR PLAN

 1:200 @ A3

			BRADLEY ST REDEVELOPMENT		DRAWING TITLE	SECOND LEVEL FLOOR PLAN
	DESCRIPTION DEVELOPMENT APPLICATION	DATE 06/12/2024	CLIENT YARRABEE PROPERTY GROUP PTY LTD	P: 02 4822 5934 ABN: 71425067537	residential commercial industrial P: 02 4822 5934 ABN: 71425067537	LOT 16 DP 1084067
		Figured dimensions take precedence. Do not scale drawings. GOULBURN N Builder to check all levels datum and dimensions on the job, conflicting information to be resolved by the project manager prior to 2580 commencing work. All materials and workmanship to be in restrict accordance with current Australian standards, BCA, Local regulation	ROSS PLACE GOULBURN NSW 2580 NOMINATED ARCHITECT:			
			and manufacturers current printed instructions. Unless noted otherwise use only best quality materials, fittings and fixtures. COPYRIGHT TIM LEE ARCHITECTS Drawings subject to copyright and may not be reproduced in any form without the written permission of the architect.	TIM LEE NSW REG: 7304 ACT REG: 1030	STREET ADDRESS	61 & 63 BRADLEY STREET GOULBUF

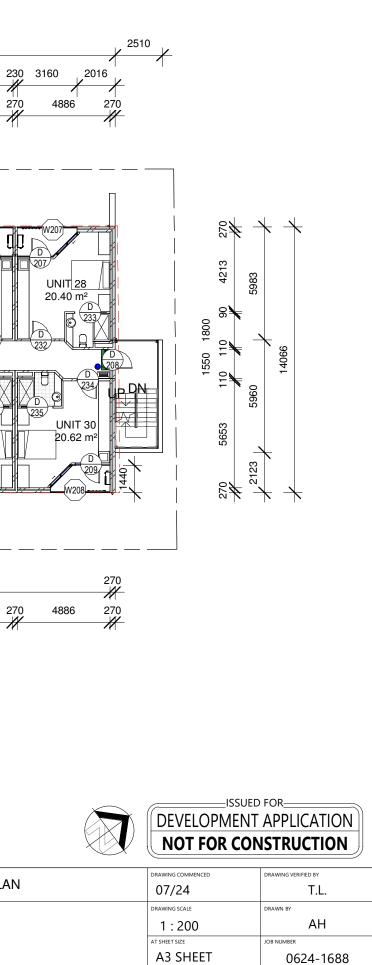



DRAWING IDENTIFICATION NUMBER

A-11


IRN

AMENDMENT ISSUE

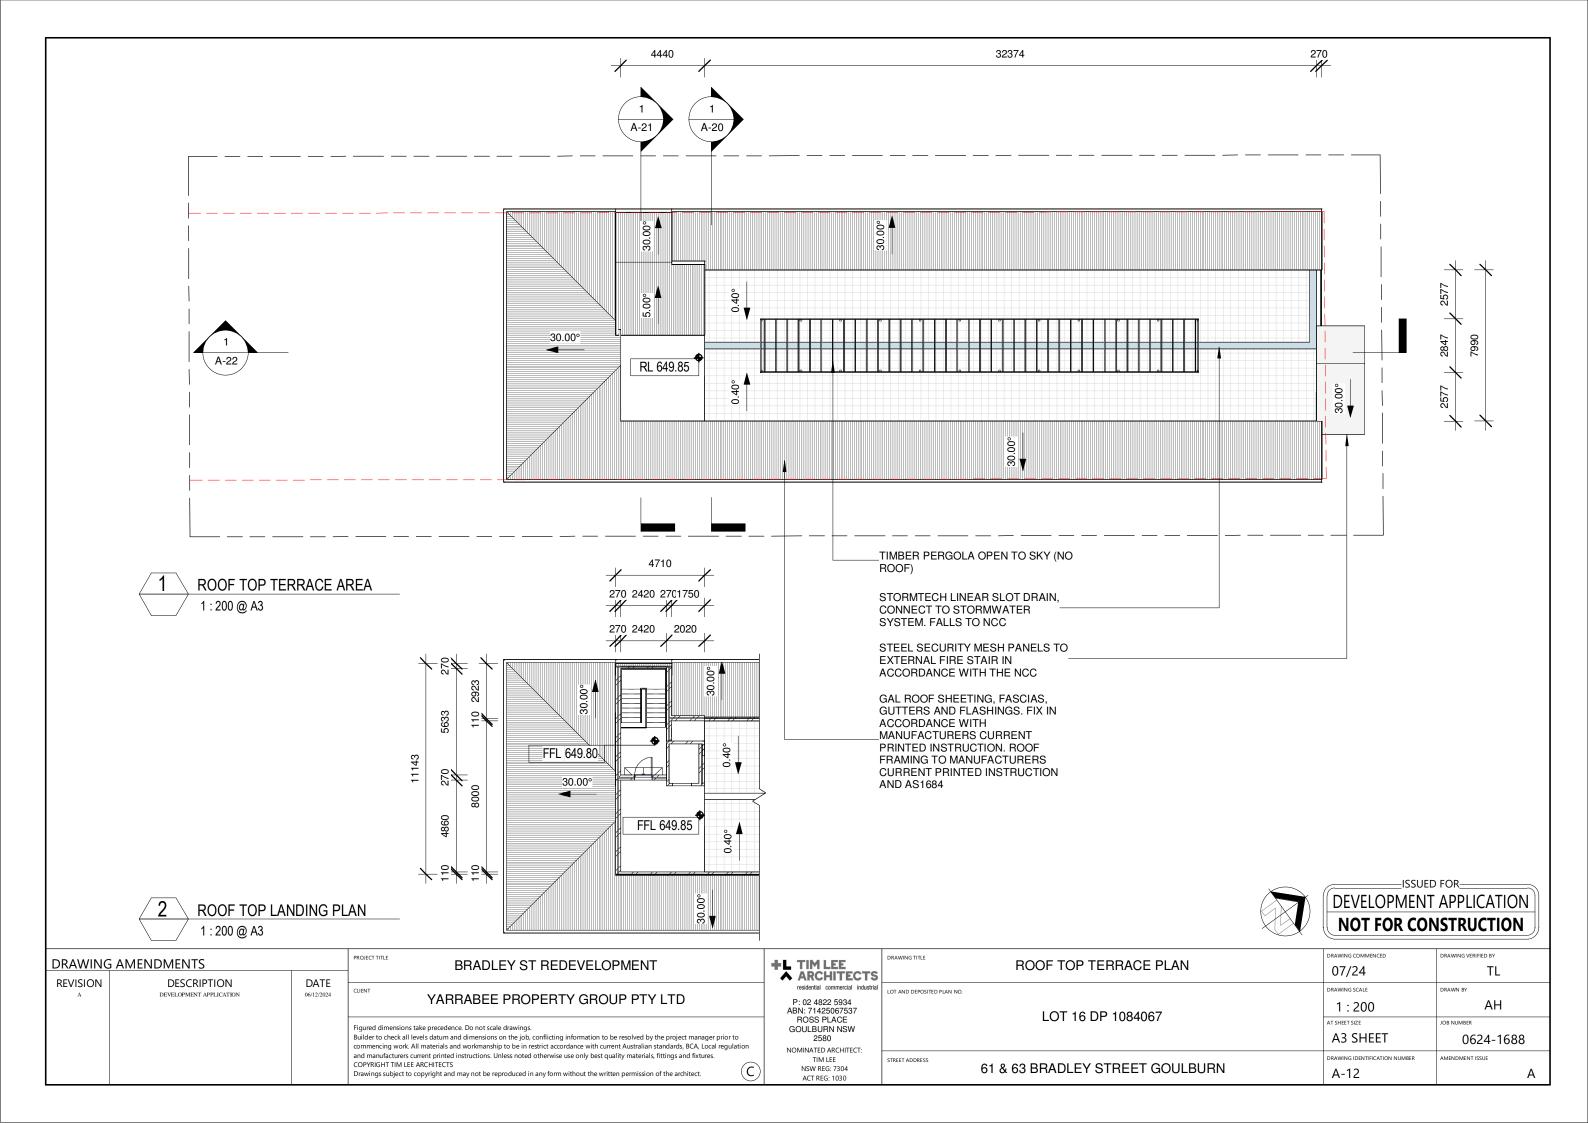

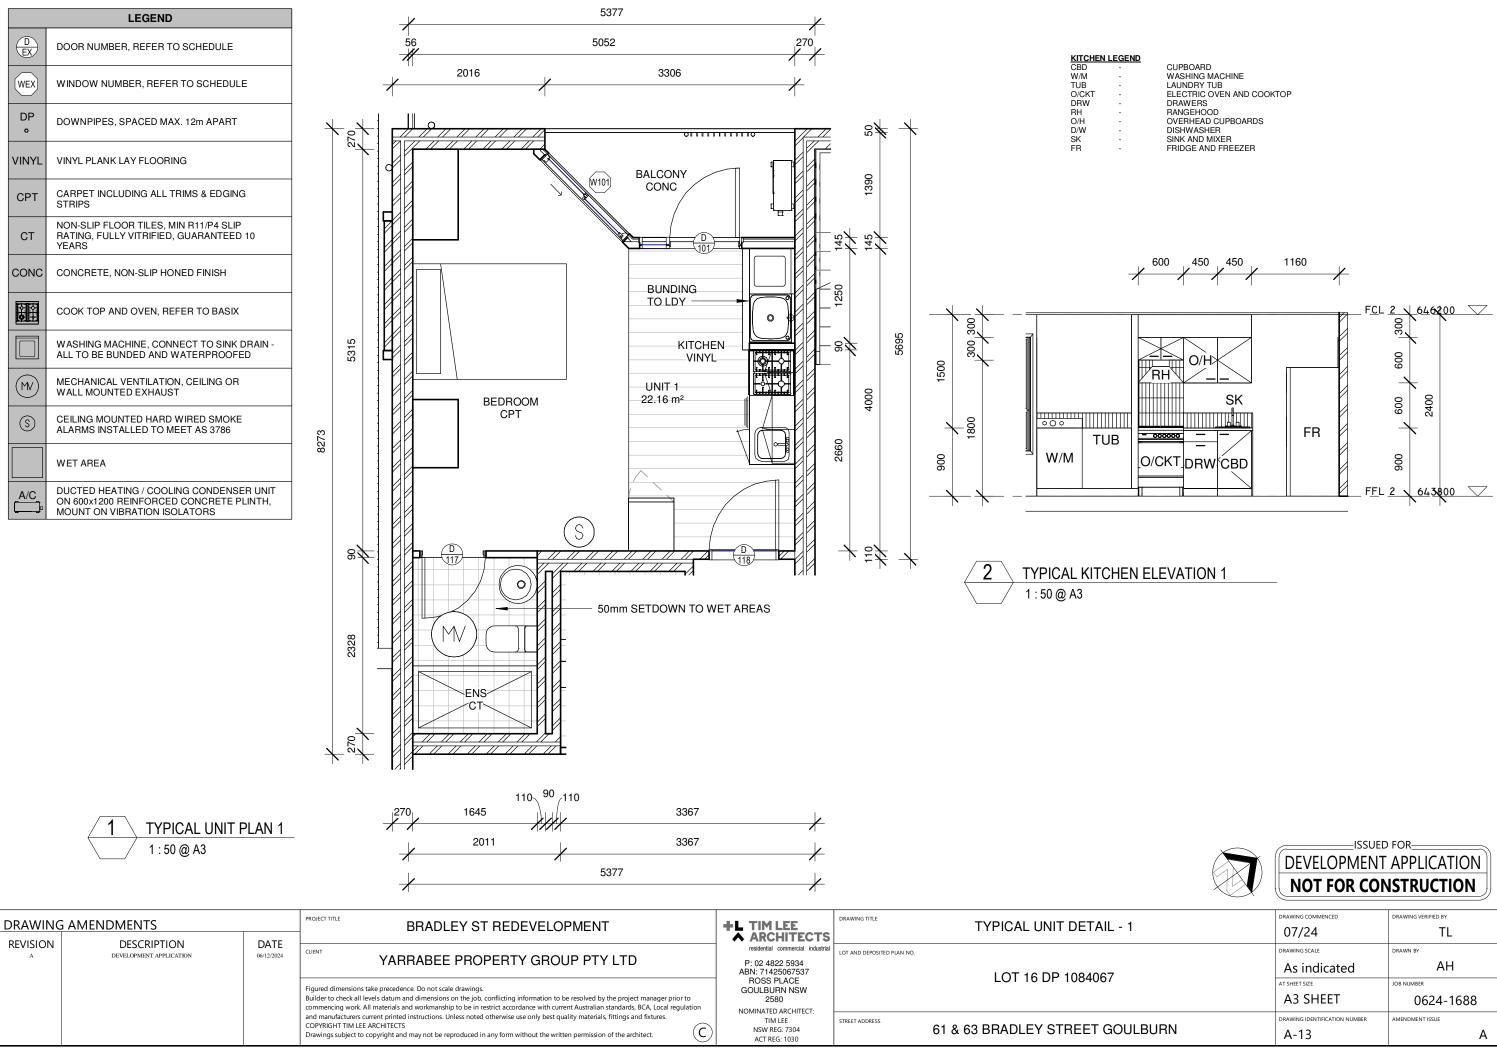


	DRAWING COMMENCED	DRAWING VERIFIED BY
	07/24	TL
	DRAWING SCALE	DRAWN BY
	As indicated	AH
	AT SHEET SIZE	JOB NUMBER
	A3 SHEET	0624-1688
	DRAWING IDENTIFICATION NUMBER	AMENDMENT ISSUE
BURN	A-13	А

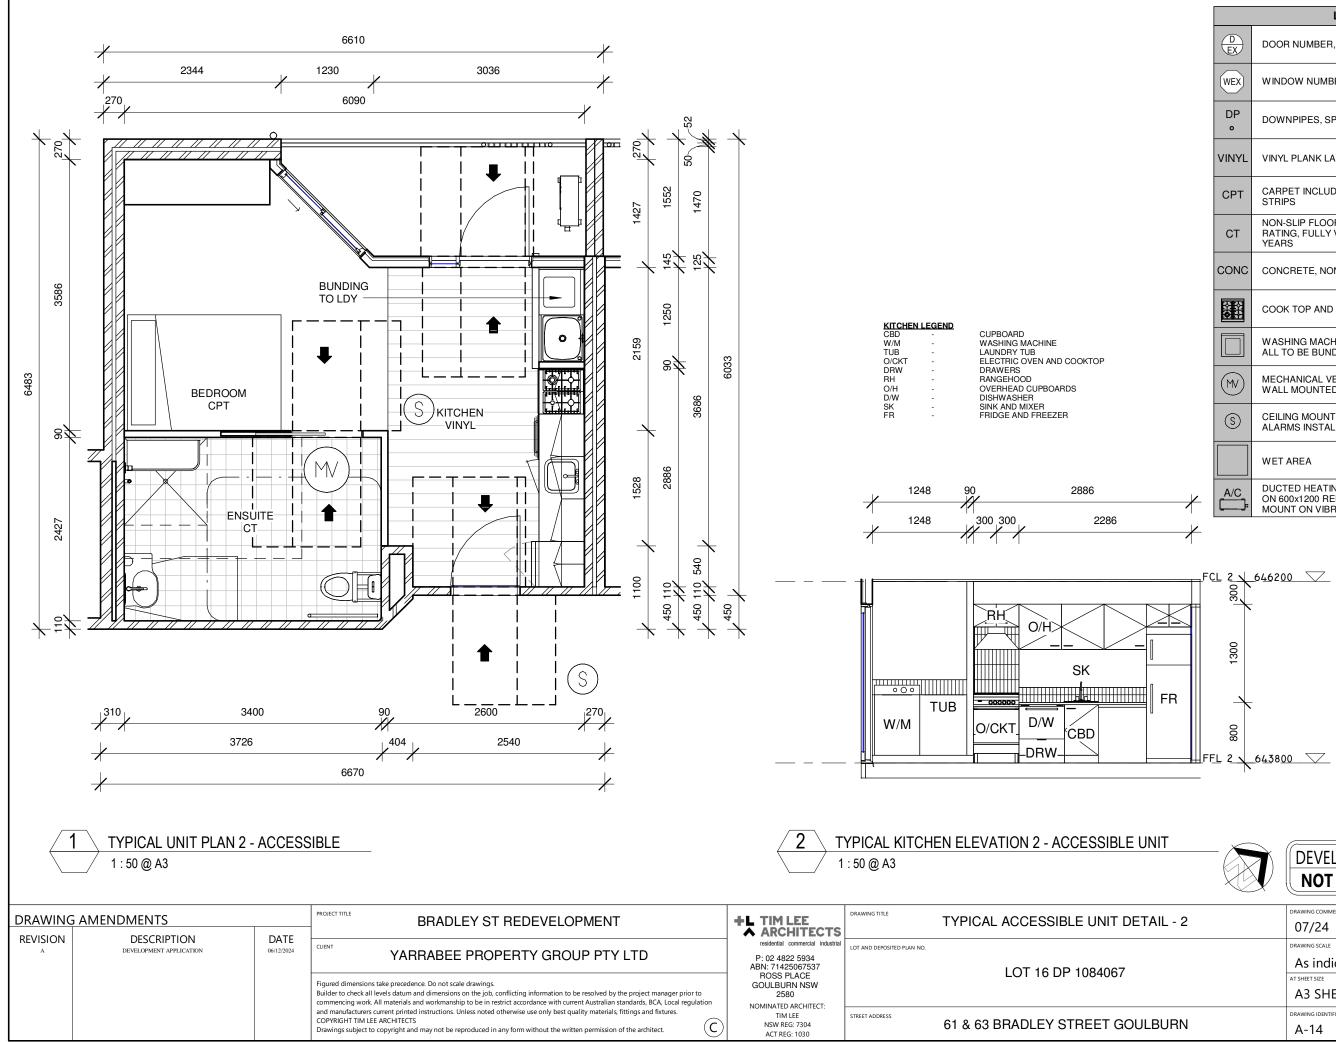

	LEGEND
D EX	DOOR NUMBER, REFER TO SCHEDULE
WEX	WINDOW NUMBER, REFER TO SCHEDULE
DP o	DOWNPIPES, SPACED MAX. 12m APART
VINYL	VINYL PLANK LAY FLOORING
СРТ	CARPET INCLUDING ALL TRIMS & EDGING STRIPS
СТ	NON-SLIP FLOOR TILES, MIN R11/P4 SLIP RATING, FULLY VITRIFIED, GUARANTEED 10 YEARS
CONC	CONCRETE, NON-SLIP HONED FINISH
	COOK TOP AND OVEN, REFER TO BASIX
	WASHING MACHINE, CONNECT TO SINK DRAIN - ALL TO BE BUNDED AND WATERPROOFED
(MV)	MECHANICAL VENTILATION, CEILING OR WALL MOUNTED EXHAUST
S	CEILING MOUNTED HARD WIRED SMOKE ALARMS INSTALLED TO MEET AS 3786
	WET AREA
_A/C₌	DUCTED HEATING / COOLING CONDENSER UNIT ON 600x1200 REINFORCED CONCRETE PLINTH, MOUNT ON VIBRATION ISOLATORS


IT	ISSUED FOR DEVELOPMENT APPLICATION NOT FOR CONSTRUCTION				
IL - 2	drawing commenced 07/24	drawing verified by TL			
	drawing scale As indicated	DRAWN BY AH			
	A3 SHEET	0624-1688			
BURN	DRAWING IDENTIFICATION NUMBER	AMENDMENT ISSUE			

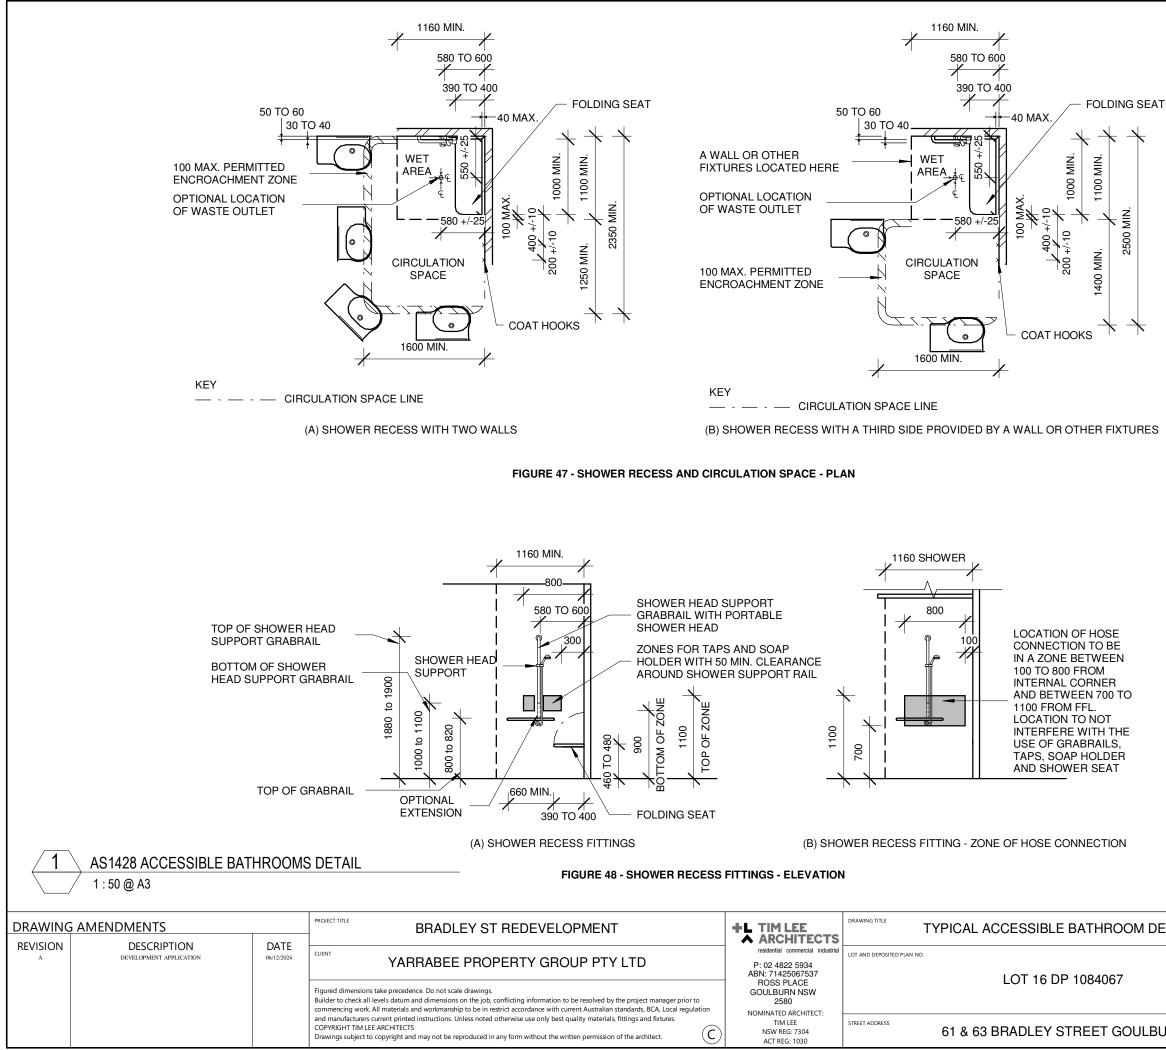

	NOT FOR CONSTRUCTION				
ETAILS	drawing commenced 07/24	drawing verified by Approver			
	drawing scale 1:50	Author			
	AT SHEET SIZE A3 SHEET	JOB NUMBER 0624-1688			
BURN	DRAWING IDENTIFICATION NUMBER	AMENDMENT ISSUE			

-ISSUED FOR-

DEVELOPMENT APPLICATION

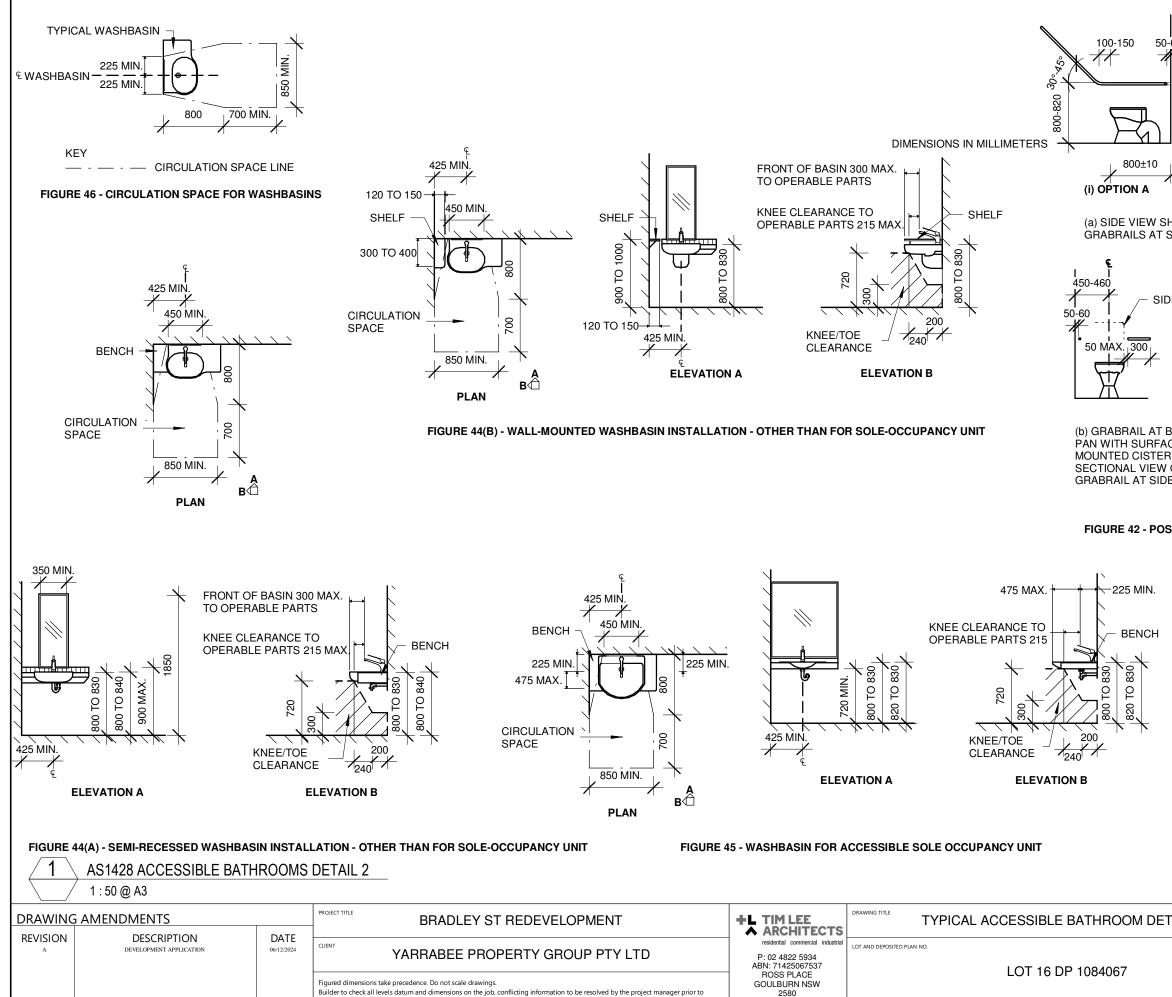

commencing work. All materials and workmanship to be in restrict accordance with current Australian standards, BCA, Local regulation and manufacturers current printed instructions. Unless noted otherwise use only best quality materials, fittings and fixtures.

Drawings subject to copyright and may not be reproduced in any form without the written permission of the architec

COPYRIGHT TIM LEE ARCHITECTS

NOMINATED ARCHITECT TIM LEE


NSW REG: 7304


ACT REG: 1030

(C)


STREET ADDRESS

(a) SIDE VIEW SHOWING OPTIONAL SY GRABRAILS AT SIDES OF PAN	€ I-460 GRABRAIL MAY
PAN WITH SURFACE- PA MOUNTED CISTERN AND RE	GRABRAIL AT BACK OF N WITH CONCEALED OR MOTE CISTERN AND CTIONAL VIEW OF
	ABRAIL AT SIDE OF PAN
FIGURE 42 - POSITION OF GRABRAILS	IN WATER CLOSETS
A75 MAX. DEEC CLEARANCE TO DEERABLE PARTS 215 CLEARANCE CLEARA	200-250 100-150 50-60 ZONE FOR POSITION OF TOILET PAPER DISPENSER 300 800±10
E OCCUPANCY UNIT	ISSUED FOR DEVELOPMENT APPLICATION NOT FOR CONSTRUCTION
PICAL ACCESSIBLE BATHROOM DETAILS 2	drawing commenced drawing verified by 07/24 TL
LOT 16 DP 1084067	DRAWING SCALE     DRAWN BY       1:50     AH       AT SHEET SIZE     JOB NUMBER       A3 SHEET     0624-1688
61 & 63 BRADLEY STREET GOULBURN	DRAWING IDENTIFICATION NUMBER AMENDMENT ISSUE
	· · · · · · · · · · · · · · · · · · ·

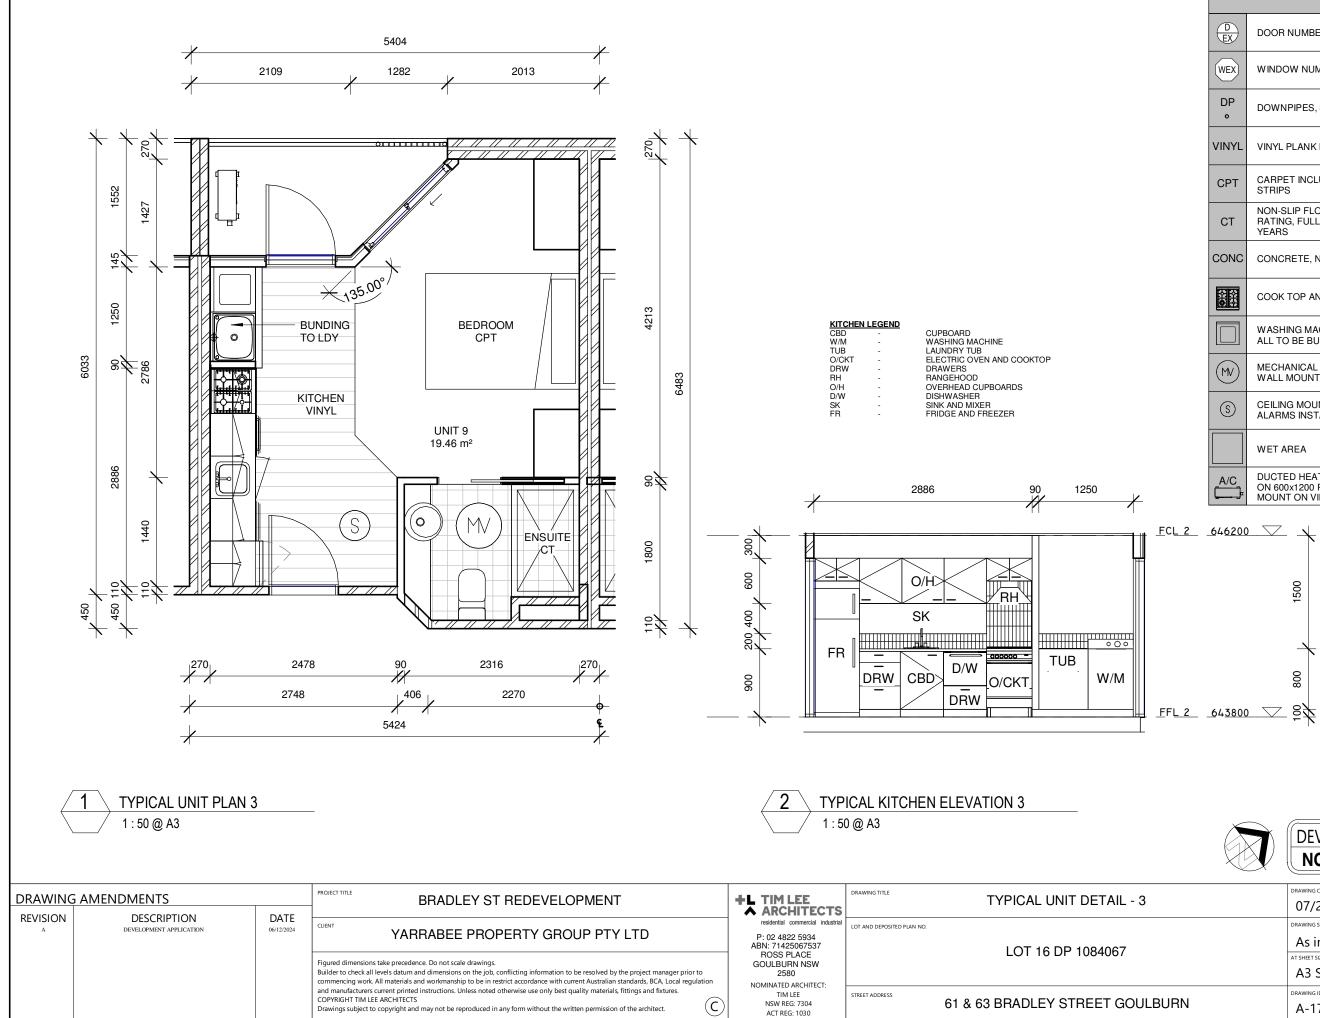

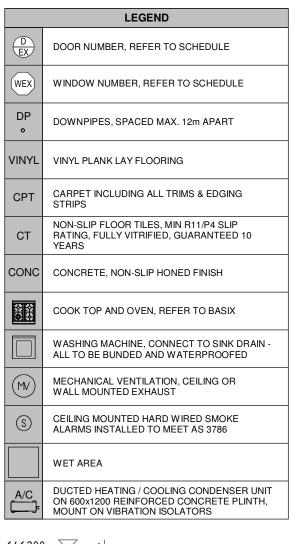


	DEVELOPMENT	
	DRAWING COMMENCED	DRAWING VERIFIED BY
	07/24	TL
	DRAWING SCALE	DRAWN BY
	As indicated	AH
	AT SHEET SIZE	JOB NUMBER
	A3 SHEET	0624-1688
	DRAWING IDENTIFICATION NUMBER	AMENDMENT ISSUE
BURN	A-17	А

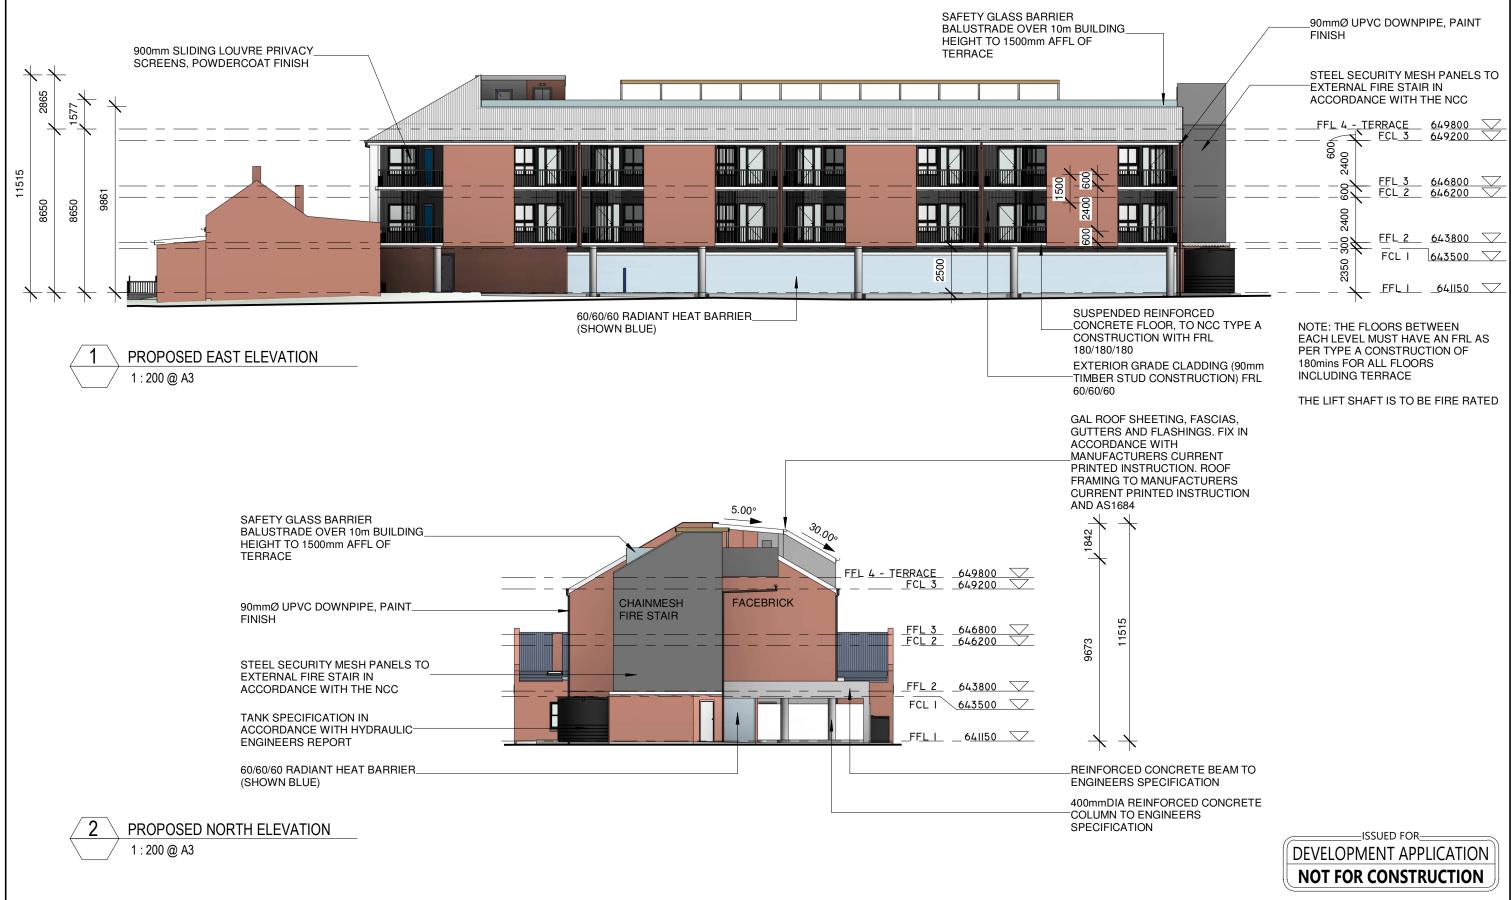


DRAWING AMENDMENTS			BRADLEY ST REDEVELOPMENT	+L TIM LEE	DRAWING TITLE ELEVATIONS	
	DESCRIPTION DEVELOPMENT APPLICATION	DATE 06/12/2024	CLIENT YARRABEE PROPERTY GROUP PTY LTD Figured dimensions take precedence. Do not scale drawings. Builder to check all levels datum and dimensions on the job, conflicting information to be resolved by the project manager prior to	P: 02 4822 5934 ABN: 71425067537 ROSS PLACE GOULBURN NSW	LOT AND DEPOSITED PLAN NO.	LOT 16 DP 1084067
			commencing work. All materials and workmanship to be in restrict accordance with current Australian standards, BCA, Local regulation and manufacturers current printed instructions. Unless noted otherwise use only best quality materials, fittings and fixtures. COPYRIGHT TIM LEE ARCHITECTS Drawings subject to copyright and may not be reproduced in any form without the written permission of the architect.	NOMINATED ARCHITECT: TIM LEE NSW REG: 7304 ACT REG: 1030	STREET ADDRESS	61 & 63 BRADLEY STREET GOULBUR

	ISSUED FOR
	DEVELOPMENT APPLICATION
ĺ	NOT FOR CONSTRUCTION

	DRAWING COMMENCED	DRAWING VERIFIED BY
	07/24	T.L.
	DRAWING SCALE	DRAWN BY
	1 : 200	AH
	AT SHEET SIZE	JOB NUMBER
	A3 SHEET	0624-1688
	DRAWING IDENTIFICATION NUMBER	AMENDMENT ISSUE
URN	A-18	А

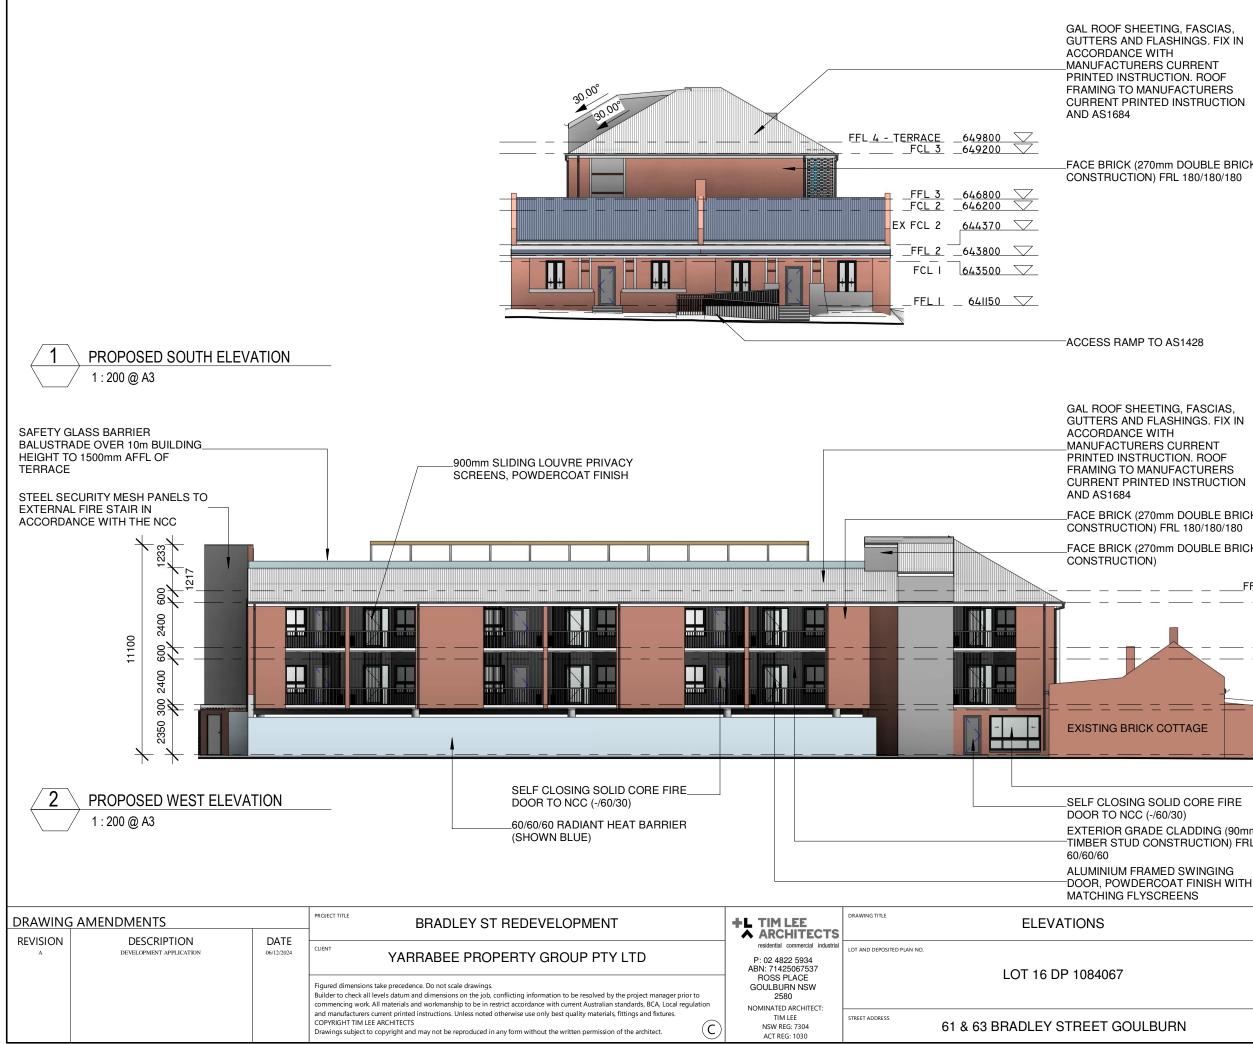

\_FACE BRICK (270mm DOUBLE BRICK FACE BRICK (270mm DOUBLE BRICK \_FACE BRICK (270mm DOUBLE BRICK FFL 4 - TERRACE 649800 FCL 3 649200 FCL 3 649200 EFL <u>3</u> 646800 FCL 2 646200 FCL 2 646200 <u>FFL 2 643800 </u> FCL I 643500 🗸 FFLI\_\_\_641150\_\_\_\_\_ ALUMINIUM FRAMED WINDOWS, -POWDERCOAT FINISH WITH MATCHING FLYSCREENS EXTERIOR GRADE CLADDING (90mm TIMBER STUD CONSTRUCTION) FRL -ISSUED FOR DEVELOPMENT APPLICATION NOT FOR CONSTRUCTION DRAWING COMMENCE AWING VERIFIED BY 07/24 T.L. RAWING SCALE RAWN BY AH 1:200 T SHEET SIZE OB NUMBER A3 SHEET 0624-1688 DRAWING IDENTIFICATION NUMBER MENDMENT ISSUE A-19 А

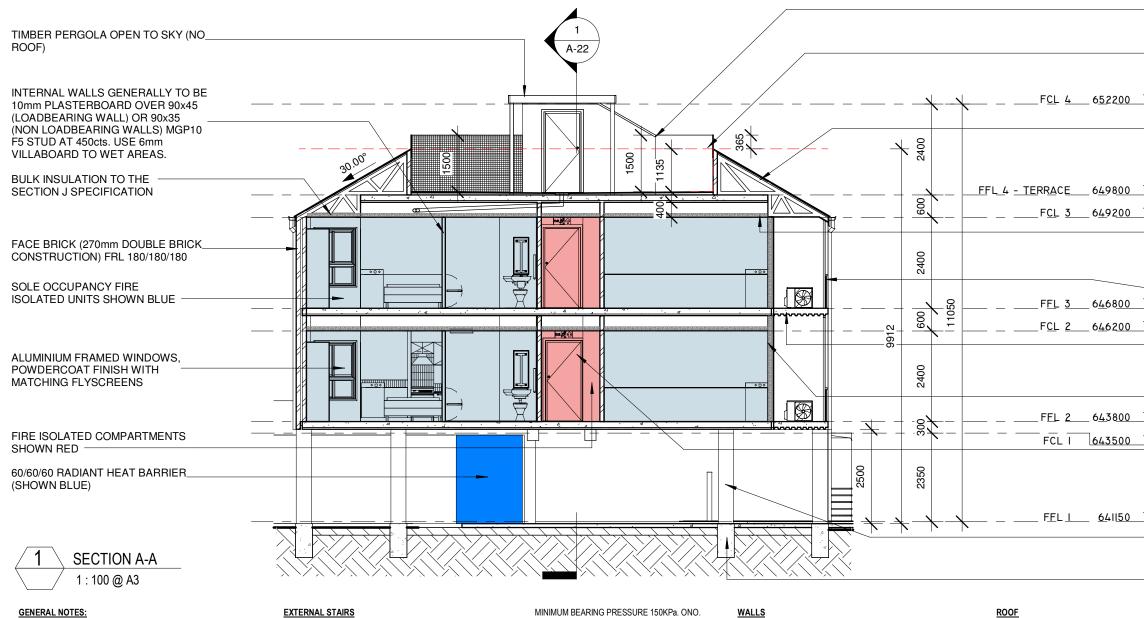

# **GENERAL NOTES:**

PROVIDE TERMITE CONTROL TO ALL AREAS AS REQUIRED BY PART B OF THE BCA, AS 3660.1 & 3660.2.

INSTALL HARD WIRED SMOKE ALARMS TO AS 3786 ADJACENT TO SI FEPING AREAS AS DIRECTED ONSITE.

ALL WALLS TO BE FULLY SARKED, CSR BRADFORD WALLWRAP XP OR EQUAL

RANGE HOODS EXHAUST SYSTEMS TO HAVE A MINIMUM FLOW RATE OF 40L/s.

EXHAUSTS FROM BATHROOMS & LAUNDRY MUST BE DISCHARGED DIRECTLY OR VIA A SHAFT OR DUCT TO OUTSIDE AIR. MECHANICAL VENTILATION & LIGHTING TO MEET PART F4 OF THE BCA. INSTALL TO MANUFACTURER'S CURRENT PRINTED INSTRUCTIONS.

CONNECT ALL NEW DOWNPIPES TO NEW WATER TANKS, OVERFLOW TO STORMWATER SYSTEM

CONNECT ALL NEW DOWNPIPES TO NEW WATER TANKS, OVERFLOW TO STORMWATER SYSTEM

### EXTERNAL STAIRS

NON-SLIP PRECAST STEPS TO BE 75mm THICK. ALL STEPS TO HAVE NON-SLIP GROOVES TO THE FRONT EDGE. ALL STEPS TO BE IN ONE PIECE FOR ITS FULL LENGTH. STAIR RISE AND GOING TO COMPLY WITH BCA D2.13 - 2R+G : GREATER THAN 550mm LESS THAN 700mm. ALL STAIR RISERS TO BE EQUAL AND COMPLY WITH BCA D2.13 - MIN, 115mm AND MAX, 190mm, MAXIMUM VARIANCE ACROSS THE STAIR LENGTH ±2mm. ALL STAIR GOINGS TO BE EQUAL TO AND COMPLY WITH BCA D2.13 -MIN. 240mm (PRIVATE), MIN. 250mm (PUBLIC) AND MAX. 355mm.

#### **CONCRETE SLABS & FOUNDATIONS**

ALL SUB-GRADE & COMPACTED FILL BELOW SLAB TO APPROVAL USING APPROVED GRANULAR MATERIAL COMPACTED TO 98% OF STANDARD DRY DENSITY. ALL FOOTINGS DOWN TO SOLID FOUNDATIONS WITH MIN. 150KPa. OR A APPROVED BY ENGINEER SITE INSPECTION PRIOR TO CONCRETE POUR. - A JAS-ANZ ACCREDITED 3RD PARTY PROCESSOR CERTIFICATE (ACRS OR EQUIVALENT) MUST BE SUPPLIED WITH ALL STEEL REINFORCEMENT AT PROCUREMENT, BEFORE ANY CONCRETE IS PLACED, TO GUARANTEE CONFORMANCE OF THE REINFORCEMENT TO AS/NZS 4671.

#### MINIMUM BEARING PRESSURE 150KPa. ONO.

FILL & FILL COMPACTION TO ENGINEER'S DETAILS

50mm SET DOWN FOR THRESHOLD AT ROLLER DOOR OPENING.

50mm SET DOWN FOR WET AREAS.

#### FRAMING

TIMBER FRAME BRACING, TIE-DOWNS & JOINT SCHEDULE TO BE DESIGNED & CERTIFIED BY THE FRAME FABRICATOR IN ACCORDANCE WITH AS1684 (NATIONALTIMBER FRAMING CODE).

# CEILINGS

10mm PLASTERBOARD CEILING LINING SCREW FIXED TO 'RONDO' CEILING BATTENS AT 450cts. 'RONDO' CEILING BATTENS NAILED TO UNDERSIDE OF TRUSSES OR JOISTS . INSTALL AL FITTINGS & FIXTURES TO MANUFACTURER'S CURRENT PRINTED INSTRUCTIONS. 90mm STANDARD PROFILE PLASTERBOARD CORNICE.

INTERNAL WALLS GENERALLY TO BE 10mm PLASTERBOARD OVER 90x45 (LOADBEARING WALL) OR 90x35 (NON LOADBEARING WALLS) MGP10 F5 STUD AT 450cts. USE 6mm VILLABOARD TO WET ARFAS

# EXTERIOR WALLS - MASONRY

WEEPHOLES TO EVERY THIRD PERPEND. SUPER ALCOR DCP OVER WEEPHOLES.

FORM 12mm EJ TO EACH BRICK SKIN WITH 50mm ABELFLEX STRIP. FILL JOINT WITH POLYETHYLENE FOAM BACKING ROD & SEAL WITH COLOURED MASTIC. EJ AT MAX. 9m cts UNLESS OTHERWISE SPECIFIED, SLIP, JOINT BETWEEN CONCRETE SLAB & SUPPORTING MASONRY WALLS. CLEAR ALL PERPENDS TO LOWEST COURSE.

### EXTERIOR WALLS - CLADDING

SELECTED EXTERIOR GRADE CLADDING OVER ENVIROSEAL OR BRADFORD WALLWRAP XP (BAL RATED). FIX INTERNAL LINING OVER INSULATION (REFER TO BASIX / NATHERS REQUIREMENTS) & SISALATION, SELECTED COLOUR EXTERIOR PAINT TO A LEVEL 4 PAINT FINISH. INSTALL TO MANUFACTURER'S CURRENT PRINTED INSTRUCTIONS.

SELECTED PROFILED SHEET STEEL RO FINISH), COLORBOND FASCIAS, GUTTER ACCORDANCE WITH MANUFACTURER INSTRUCTIONS. ROOF FRAMING & ROO

# WET AREAS

WET AREAS SHOWN HATCHED, LAY SEL CERAMIC TILES TO EQUAL R11 / P4 ON GIVE FALLS TO FW'S AS SHOWN. AREAS ACCORDANCE WITH AUSTRALIAN STAN AS 3740 WATERPROOFING OF WET AR BUILDINGS

THE WATERPROOFING SYSTEM TO BE BASE CONSTRUCTION. DO NOT WATER BOARD OR TIMBER FLOORING


PROVIDE EVIDENCE OF MANUFACTURE **INSTALLATION DATA SHEETS & REQUI** 

INSTALL ALL PRODUCTS TO MANUFACT PRINTED INSTRUCTIONS.

						SECTION A-A
REVISION	DESCRIPTION DEVELOPMENT APPLICATION	DATE 06/12/2024	CLIENT YARRABEE PROPERTY GROUP PTY LTD	residential commercial industrial P: 02 4822 5934 ABN: 71425067537		LOT 16 DP 1084067
			Figured dimensions take precedence. Do not scale drawings. Builder to check all levels datum and dimensions on the job, conflicting information to be resolved by the project manager prior to commencing work. All materials and workmanship to be in restrict accordance with current Australian standards, BCA, Local regulation	dimensions on the job, conflicting information to be resolved by the project manager prior to 2580		
			and manufacturers current printed instructions. Unless noted otherwise use only best quality materials, fittings and fixtures. COPYRIGHT TIM LEE ARCHITECTS Drawings subject to copyright and may not be reproduced in any form without the written permission of the architect.	TIM LEE NSW REG: 7304 ACT REG: 1030	STREET ADDRESS	61 & 63 BRADLEY STREET GOULBURN

			IRITY MESH	I PANELS T	0	
			CE WITH TH			
	-		SS BARRIE	R m BUILDING		
	HEIGHT	TO 1	500mm AFI			
	TERRAC		HEETING, I			
$\bigtriangledown$			ND FLASHIN			
	ACCORD		CE WITH			
			STRUCTION			
	AND AS1					
$\bigtriangledown$			ERBOARD			
$\bigtriangledown$			EW FIXED T CEILING S	O 'RONDO'		
	_450cts. IN	NST/	ALL AL FITT	INGS &		
			D MANUFA	STURER'S	6.	
	90mm ST	ANE	DARD PROP	FILE	-	
				ICE		
$\bigtriangledown$	BALUSTI	RAD	E TO NCC			
$\bigtriangledown$	SUSPEN	DED		CED		
				NCC TYPE	A	
	180/180/1		ION WITH I	FRL		
	EXTERIC	)R G	BADE CLA	DDING (90m	m	
	TIMBER	STU	D CONSTR	UCTION) FR	L	
$\bigtriangledown$	60/60/60					
$\bigtriangledown$	SELE CL	OSIN	NG SOLID C			
			C (-/60/30)			
$\bigtriangledown$	400 ····· D					
			ENGINEER	D CONCRET IS	E	
	SPECIFIC	CATI	ON			
					3	
	TO ENGI	NEE	RS SPECIF	ICATION		
		<u>tilin</u>	IG			
OFING (COLO RS & FLASHING	GS. FIX IN		IG TO BE COMP IT JOINTS.	LETED WITH NO	RAISED EDGES OR	
S CURRENT PR OF BATTTENS T		APPROPRIATE TRIMS & FINISH BEADS TO BE INSTALLED.				
		SUB-STANDARD TILING WILL BE REJECTED. REJECTED				
LECTED NON-S	SLIP			VED. BASE WOR N MATCHING MA	K IS TO BE TERIALS SUPPLIED &	
MORTAR BED		LAID	AT CONTRACT	OR'S EXPENSE.		
NDARDS						
EAS WITHIN RE	SIDENTIAL	REI	FER TO CO	MPLIANCE	NOTE SHEET	
APPROPRIATE	FOR THE	FOI	R GENERA	L NOTES.		
RPROOF OVER	PARTICLE					
ER'S PRODUCT						
REMENTS.					)	
TURER'S CURF	RENT				APPLICATION	
			<b>NOT</b>	OR CON	ISTRUCTION	
			DRAWING COMMENC	ED	DRAWING VERIFIED BY	
			07/24		TL	
			DRAWING SCALE		DRAWN BY	
			1:100		AH	
			AT SHEET SIZE		JOB NUMBER	
			A3 SHEE		0624-1688	
			DRAWING IDENTIFICA	ATION NUMBER	AMENDMENT ISSUE	

A-20

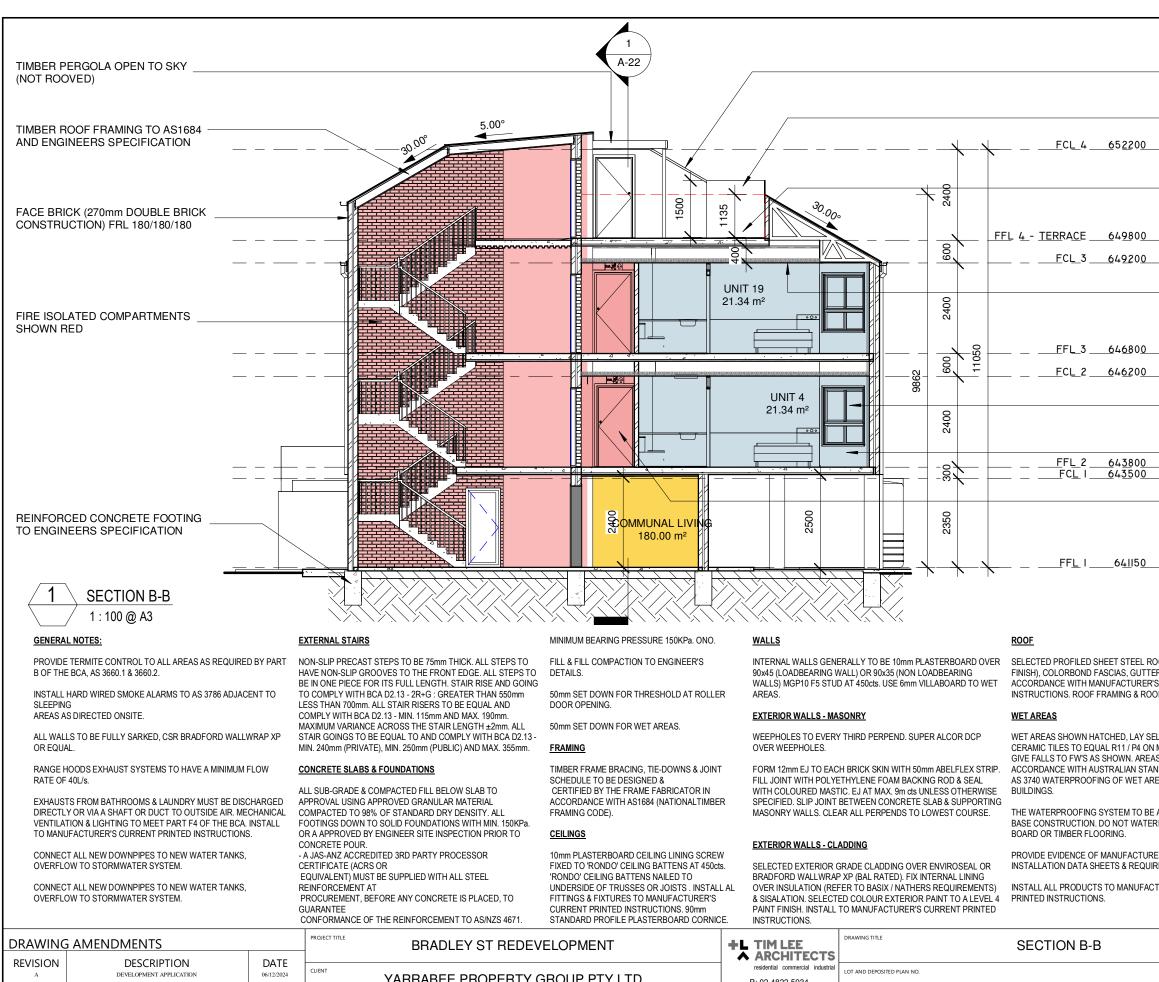


REVISION	DESCRIPTION	DATE		▲ ARCHITECTS			
A			CLIENT	YARRABEE PROPERTY GROUP PTY LTD	residential commercial industrial P: 02 4822 5934 ABN: 71425067537	P: 02 4822 5934	
			Figured dimensions take precedence. Do not scale drawings. Builder to check all levels datum and dimensions on the job, conflicting information to be resolved by the project manager prior to commencing work. All materials and workmanship to be in restrict accordance with current Australian standards, BCA, Local regulation	ROSS PLACE GOULBURN NSW 2580 NOMINATED ARCHITECT:		LOT 16 DP 1084067	
			and manufacturers current printed instructions. Unless noted otherwise use only best quality materials, fittings and fixtures. COPYRIGHT TIM LEE ARCHITECTS Drawings subject to copyright and may not be reproduced in any form without the written permission of the architect.	TIM LEE NSW REG: 7304 ACT REG: 1030	STREET ADDRESS	61 & 63 BRADLEY STREET GOULBURN	

	-	EEL SECURITY MESH PAN E STAIR IN ACCORDANCE	
	Ô٧	FETY GLASS BARRIER BA ER 10m BUILDING HEIGHT FL OF TERRACE	
	AN MA INS MA	L ROOF SHEETING, FASC D FLASHINGS. FIX IN ACC NUFACTURERS CURRENT TRUCTION. ROOF FRAMI NUFACTURERS CURRENT TRUCTION AND AS1684	ORDANCE WITH F PRINTED NG TO
	SC CE FIT CU ST	nm PLASTERBOARD CEILI REW FIXED TO 'RONDO' S ILING SYSTEM AT 450cts. I TINGS & FIXTURES TO MA RRENT PRINTED INSTRUC ANDARD PROFILE PLASTE RNICE.	USPENDED INSTALL ALL INUFACTURERS CTIONS. 90mm
$\nabla$			
	PO	JMINIUM FRAMED WINDO WDERCOAT FINISH WITH /SCREENS	2
$\overline{\mathbf{a}}$		LE OCCUPANCY FIRE ISO OWN BLUE	LATED UNITS
	-	LF CLOSING SOLID CORE C (-/60/30)	FIRE DOOR TO
$\bigtriangledown$			
OOFING (COLORBOND		TILING TILING TO BE COMPLETED WITH NO	
RS & FLASHINGS. FIX II S CURRENT PRINTED	N	TIGHT JOINTS.	
OF BATTTENS TO AS168	84.	APPROPRIATE TRIMS & FINISH BEA	
ELECTED NON-SLIP MORTAR BED GRADED S TO BE TREATED IN NDARDS	) TO	SUB-STANDARD TILING WILL BE RE WORK TO BE REMOVED. BASE WOR REPREPARED & NEW MATCHING M. LAID AT CONTRACTOR'S EXPENSE.	RK IS TO BE ATERIALS SUPPLIED &
EAS WITHIN RESIDENT	IAL	REFER TO COMPLIANCE	NOTE SHEET
APPROPRIATE FOR TH RPROOF OVER PARTIC		FOR GENERAL NOTES.	
ER'S PRODUCT REMENTS.		ISSUED	FOR
TURER'S CURRENT		DEVELOPMENT NOT FOR CON	
			DRAWING VERIFIED BY
		07/24 drawing scale	TL DRAWN BY
		1 : 100	АН
		AT SHEET SIZE	JOB NUMBER 0624-1688

DRAWING IDENTIFICATION NUMBER

A-21

AMENDMENT ISSUE

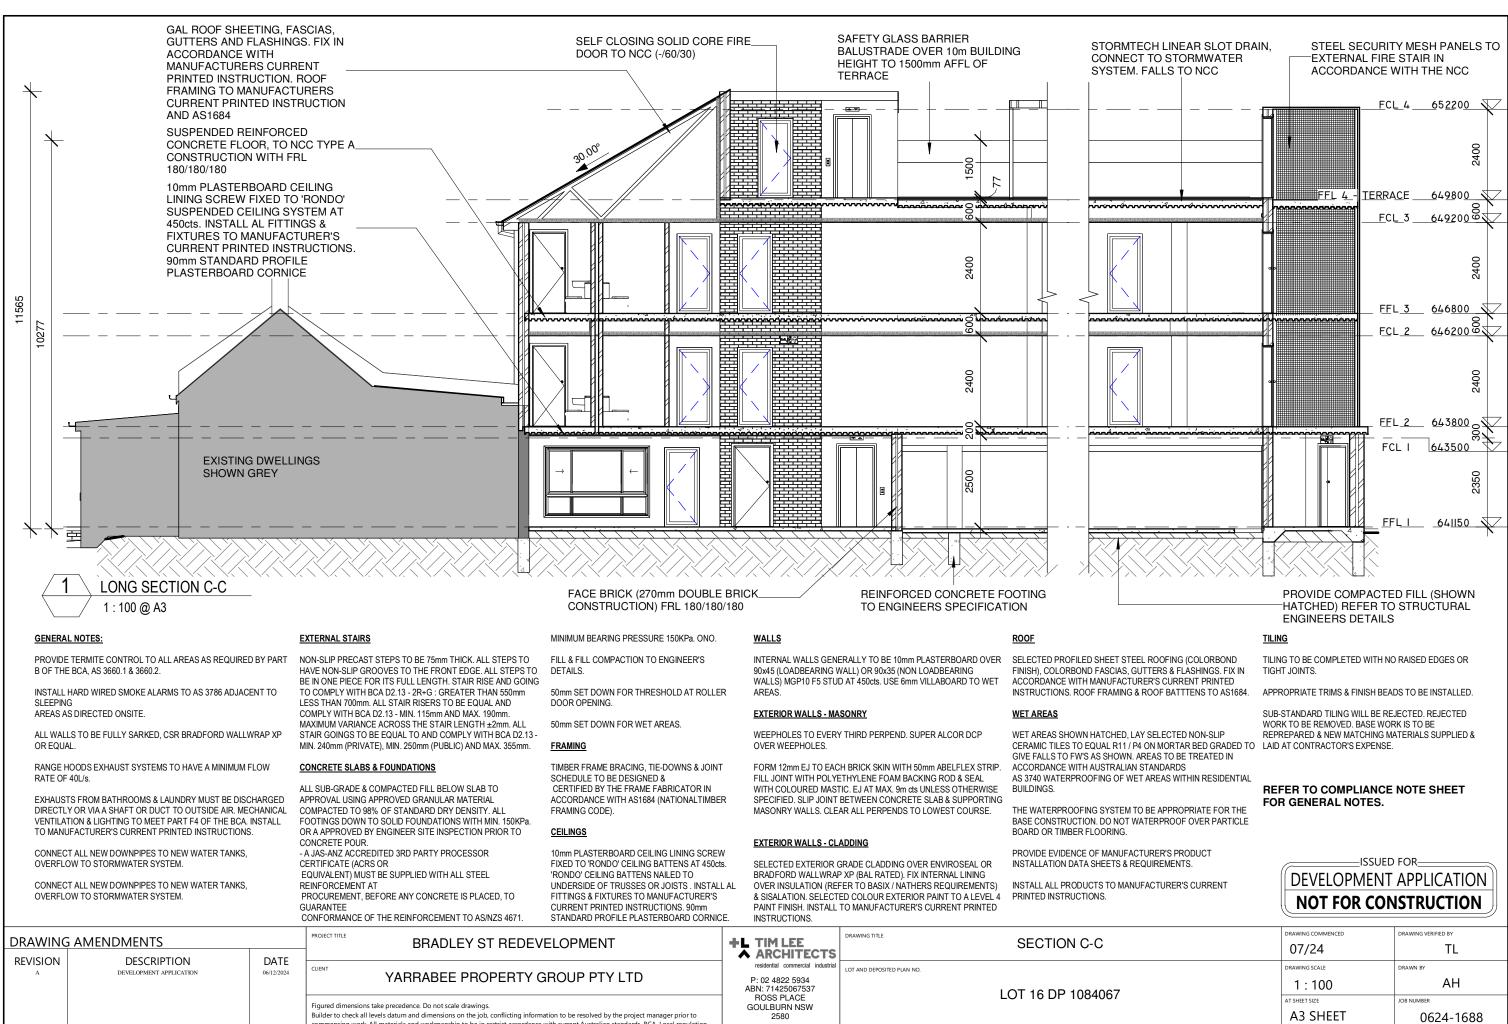

						SECTION C-C
REVISION	DESCRIPTION	DATE		▲ ARCHITECTS		
	DESCRIPTION DEVELOPMENT APPLICATION	06/12/2024	YARRABEE PROPERTY GROUP PTY LTD	residential commercial industrial P: 02 4822 5934 ABN: 71425067537	LOT AND DEPOSITED PLAN NO.	LOT 16 DP 1084067
			Figured dimensions take precedence. Do not scale drawings. Builder to check all levels datum and dimensions on the job, conflicting information to be resolved by the project manager prior to commencing work. All materials and workmanship to be in restrict accordance with current Australian standards, BCA, Local regulation	ROSS PLACE GOULBURN NSW 2580 NOMINATED ARCHITECT:		LOT 16 DP 1084067
			and manufacturers current printed instructions. Unless noted otherwise use only best quality materials, fittings and fixtures. COPYRIGHT TIM LEE ARCHITECTS Drawings subject to copyright and may not be reproduced in any form without the written permission of the architect.	TIM LEE NSW REG: 7304 ACT REG: 1030	STREET ADDRESS	61 & 63 BRADLEY STREET GOULBU

URN

AMENDMENT ISSUE


DRAWING IDENTIFICATION NUMBER

A-22


Α



Figured dimensions take precedence. Do not scale drawings.         Builder to check all levels datum and dimensions on the job, conflicting information to be resolved by the project manager prior to commencing work. All materials and workmanship to be in restrict accordance with current Australian standards, BCA, Local regulation and manufacturers current printed instructions. Unless noted otherwise use only best quality materials, fittings and fixtures.         COPYRIGHT TIM LEE ARCHITECTS       Drawings subject to copyright and may not be reproduced in any form without the written permission of the architect.	GOULBURN NSW 2580 NOMINATED ARCHITECT: TIM LEE NSW REG: 7304 ACT REG: 1030	STREET ADDRESS 61 & 63 BRADLEY STREET GO
--	---	--

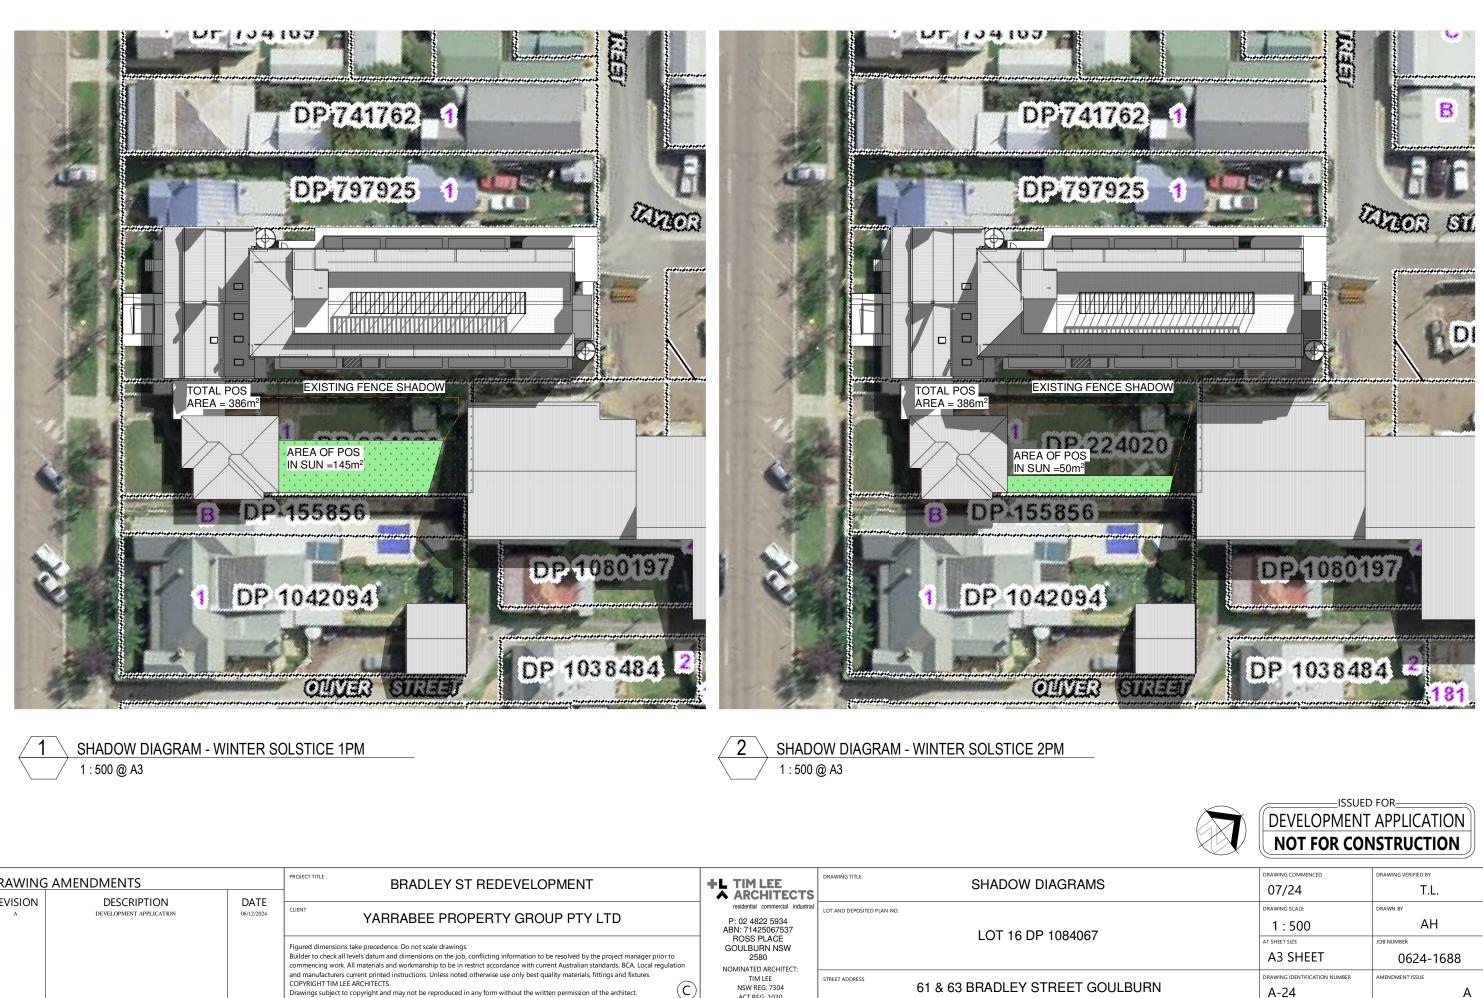

			BRADLEY ST REDEVELOPMENT	+L TIM LEE ARCHITECTS	DRAWING TITLE	SHADOW DIAGRAMS
REVISION	DESCRIPTION DEVELOPMENT APPLICATION	DATE 06/12/2024	VARRABEE PROPERTY GROUP PTY LTD	residential commercial industrial P: 02 4822 5934 ABN: 71425067537	LOT AND DEPOSITED PLAN NO.	LOT 16 DP 1084067
			Figured dimensions take precedence. Do not scale drawings. Builder to check all levels datum and dimensions on the job, conflicting information to be resolved by the project manager prior to commencing work. All materials and workmanship to be in restrict accordance with current Australian standards, BCA, Local regulation	ROSS PLACE GOULBURN NSW 2580 NOMINATED ARCHITECT:		LOT 10 DF 1064007
			and manufacturers current printed instructions. Unless noted otherwise use only best quality materials, fittings and fixtures. COPYRIGHT TIM LEE ARCHITECTS Drawings subject to copyright and may not be reproduced in any form without the written permission of the architect.	NOMINATED ARCHITECT: TIM LEE NSW REG: 7304 ACT REG: 1030	STREET ADDRESS	61 & 63 BRADLEY STREET GOULBU

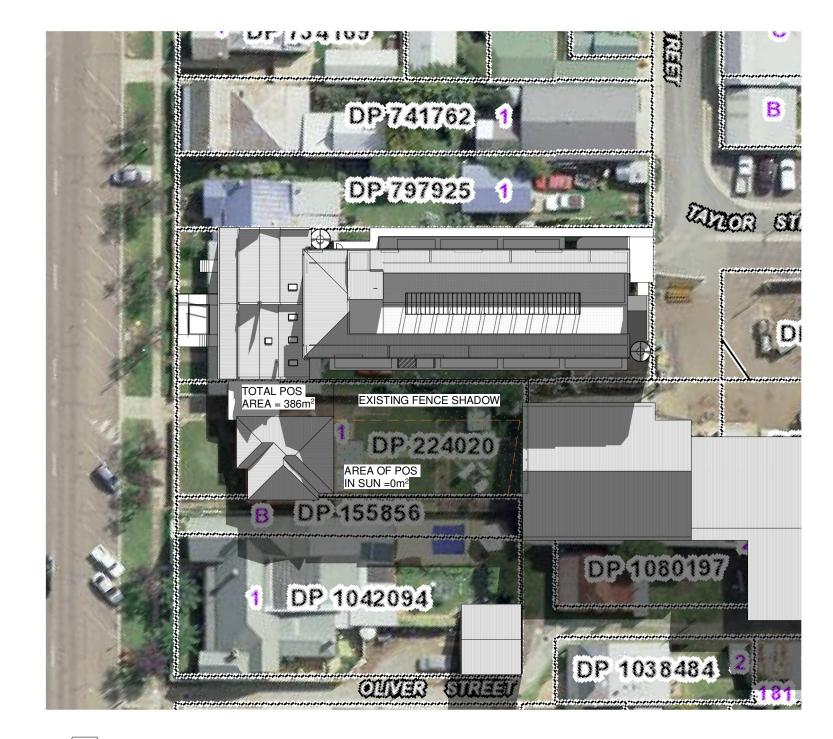

SHADOW DIAGRAM - WINTER SOLSTICE 3PM 1 : 500 @ A3

						NOT FOR CON	ISTRUCTION
		DATE	PROJECT TITLE BRADLEY ST REDEVELOPMENT	+L TIM LEE ARCHITECTS	DRAWING TITLE SHADOW DIAGRAMS	DRAWING COMMENCED	drawing verified by T.L.
		DATE 06/12/2024	VARRABEE PROPERTY GROUP PTY LTD	residential commercial industrial P: 02 4822 5934 ABN: 71425067537	LOT AND DEPOSITED PLAN NO.	drawing scale 1:500	DRAWN BY
			Figured dimensions take precedence. Do not scale drawings. Builder to check all levels datum and dimensions on the job, conflicting information to be resolved by the project manager prior to commencing work. All materials and workmanship to be in restrict accordance with current Australian standards, BCA, Local regulation	ROSS PLACE GOULBURN NSW 2580 NOMINATED ARCHITECT:	LOT 16 DP 1084067	AT SHEET SIZE A3 SHEET	JOB NUMBER 0624-1688
			and manufacturers current printed instructions. Unless noted otherwise use only best quality materials, fittings and fixtures. COPYRIGHT TIM LEE ARCHITECTS Drawings subject to copyright and may not be reproduced in any form without the written permission of the architect.	TIM LEE NSW REG: 7304 ACT REG: 1030	STREET ADDRESS 61 & 63 BRADLEY STREET GOULBURN	DRAWING IDENTIFICATION NUMBER	AMENDMENT ISSUE

ISSUED FOR\_\_\_\_\_

	DOOR SCHEDULE		DOOR SCHEDULE								
DOOR NO.	DOOR TYPE	HEIGHT	WIDTH	SILL HEIGHT	HEAD HEIGHT	OOR NO.	DOOR TYPE	HEIGHT	WIDTH	SILL HEIGHT	HEAD HEIGHT
01	SELF CLOSING SOLID CORE FIRE DOOR TO NCC (-/60/30)	2100	920	0 2	2100 14	45	TIMBER FRAMED, HOLLOW CORE CAVITY SLIDING	2040	820	0	2040
02	SELF CLOSING SOLID CORE FIRE DOOR TO NCC (-/60/30)	2100	920			46	SELF CLOSING SOLID CORE FIRE DOOR TO NCC (-/60/30)	2100	920	0	2100
03	SELF CLOSING SOLID CORE FIRE DOOR TO NCC (-/60/30)	2100	920			47	SOLID CORE INTERNAL SWINGING DOOR	2100	820	0	2100
04	SELF CLOSING SOLID CORE FIRE DOOR TO NCC (-/60/30)	2100	920	0 2	2100 14	48	SELF CLOSING SOLID CORE FIRE DOOR TO NCC (-/60/30)	2100	920	0	2100
05	SELF CLOSING SOLID CORE FIRE DOOR TO NCC (-/60/30)	2100	920	0 2	2100 20	01	ALUMINIUM FRAMED SWINGING DOOR, POWDERCOAT FINISH WITH	2100	1000	0	2100
06	SELF CLOSING SOLID CORE FIRE DOOR TO NCC (-/60/30)	2100	920		2100	~~		0100	1000		0100
07	SELF CLOSING SOLID CORE FIRE DOOR TO NCC (-/60/30)	2100	920		2100 20	02	ALUMINIUM FRAMED SWINGING DOOR, POWDERCOAT FINISH WITH MATCHING FLYSCREENS	2100	1000	0	2100
08	SOLID CORE INTERNAL SWINGING DOOR	2100	720		2100 20	03	SELF CLOSING SOLID CORE FIRE DOOR TO NCC (-/60/30)	2100	920	0	2100
09	SOLID CORE INTERNAL SWINGING DOOR SOLID CORE INTERNAL SWINGING DOOR	2100	720		2100	04	ALUMINIUM FRAMED SWINGING DOOR, POWDERCOAT FINISH WITH	2100	1000	0	2100
10	ALUMINIUM FRAMED SWINGING DOOR ALUMINIUM FRAMED SWINGING DOOR, POWDERCOAT FINISH WITH	2100 2100	920	0 E	2100 2100 2100 2100 2100 2100 2100 2100	-	MATCHING FLYSCREENS			-	
101	MATCHING FLYSCREENS	2100	1000		2100 20	05	SELF CLOSING SOLID CORE FIRE DOOR TO NCC (-/60/30)	2100	920	0	2100
102	ALUMINIUM FRAMED SWINGING DOOR, POWDERCOAT FINISH WITH MATCHING FLYSCREENS	2100	1000	0 2	2100 20	06	ALUMINIUM FRAMED SWINGING DOOR, POWDERCOAT FINISH WITH MATCHING FLYSCREENS	2100	1000	0	2100
103	SELF CLOSING SOLID CORE FIRE DOOR TO NCC (-/60/30)	2100	920	0 2	2100 20	07	SELF CLOSING SOLID CORE FIRE DOOR TO NCC (-/60/30)	2100	920	0	2100
100	ALUMINIUM FRAMED SWINGING DOOR, POWDERCOAT FINISH WITH	2100	1000		2100 20	08	SELF CLOSING SOLID CORE FIRE DOOR TO NCC (-/60/30)	2100	920	0	2100
-	MATCHING FLYSCREENS				20	09	ALUMINIUM FRAMED SWINGING DOOR, POWDERCOAT FINISH WITH	2100	1000	0	2100
105	SELF CLOSING SOLID CORE FIRE DOOR TO NCC (-/60/30)	2100	920		2100 21	10	MATCHING FLYSCREENS ALUMINIUM FRAMED SWINGING DOOR, POWDERCOAT FINISH WITH	2100	1000	0	2100
106	ALUMINIUM FRAMED SWINGING DOOR, POWDERCOAT FINISH WITH MATCHING FLYSCREENS	2100	1000	0 2	2100		MATCHING FLYSCREENS		1000	Ŭ	
107	SELF CLOSING SOLID CORE FIRE DOOR TO NCC (-/60/30)	2100	920	0 2	2100 21	11	ALUMINIUM FRAMED SWINGING DOOR, POWDERCOAT FINISH WITH MATCHING FLYSCREENS	2100	1000	0	2100
108	SELF CLOSING SOLID CORE FIRE DOOR TO NCC (-/60/30)	2100	920		2100 21	12	ALUMINIUM FRAMED SWINGING DOOR, POWDERCOAT FINISH WITH	2100	1000	0	2100
109	ALUMINIUM FRAMED SWINGING DOOR, POWDERCOAT FINISH WITH MATCHING FLYSCREENS	2100	1000	0 2	2100		MATCHING FLYSCREENS				
110	ALUMINIUM FRAMED SWINGING DOOR, POWDERCOAT FINISH WITH MATCHING FLYSCREENS	2100	1000	0 2	2100 21	13	ALUMINIUM FRAMED SWINGING DOOR, POWDERCOAT FINISH WITH MATCHING FLYSCREENS	2100	1000	0	2100
111	ALUMINIUM FRAMED SWINGING DOOR, POWDERCOAT FINISH WITH MATCHING FLYSCREENS	2100	1000	0 2	2100 21	14	ALUMINIUM FRAMED SWINGING DOOR, POWDERCOAT FINISH WITH MATCHING FLYSCREENS	2100	1000	0	2100
112	ALUMINIUM FRAMED SWINGING DOOR, POWDERCOAT FINISH WITH MATCHING FLYSCREENS	2100	1000	0 2	2100 21		ALUMINIUM FRAMED SWINGING DOOR, POWDERCOAT FINISH WITH MATCHING FLYSCREENS	2100	1000	0	2100
113	ALUMINIUM FRAMED SWINGING DOOR, POWDERCOAT FINISH WITH	2100	1000	0 2	2100 21		ALUMINIUM FRAMED GLAZED SWINING DOOR, POWDERCOAT FINISH	2100	820	0	2100
	MATCHING FLYSCREENS				21		TIMBER FRAMED, HOLLOW CORE SWINGING DOOR	2100	820	0	2100
114	ALUMINIUM FRAMED SWINGING DOOR, POWDERCOAT FINISH WITH	2100	1000	0 2	2100 21 21		SELF CLOSING SOLID CORE FIRE DOOR TO NCC (-/60/30) SELF CLOSING SOLID CORE FIRE DOOR TO NCC (-/60/30)	2100 2100	920	0	2100
115	MATCHING FLYSCREENS ALUMINIUM FRAMED SWINGING DOOR, POWDERCOAT FINISH WITH	2100	1000	0 2		20	TIMBER FRAMED, HOLLOW CORE SWINGING DOOR	2100	820	0	2100
115	MATCHING FLYSCREENS	2100	1000	0	2100 22		SELF CLOSING SOLID CORE FIRE DOOR TO NCC (-/60/30)	2100	920	0	2100
116	ALUMINIUM FRAMED GLAZED SWINING DOOR, POWDERCOAT FINISH	2100	820	0 2	2100 22	22	SELF CLOSING SOLID CORE FIRE DOOR TO NCC (-/60/30)	2100	920	0	2100
117	SOLID CORE INTERNAL SWINGING DOOR	2100	820	0 2	2100 22	23	TIMBER FRAMED, HOLLOW CORE CAVITY SLIDING	2040	920	0	2040
118	SELF CLOSING SOLID CORE FIRE DOOR TO NCC (-/60/30)	2100	920	0 2	2100 22		SELF CLOSING SOLID CORE FIRE DOOR TO NCC (-/60/30)	2100	920	0	2100
119	SELF CLOSING SOLID CORE FIRE DOOR TO NCC (-/60/30)	2100	920			25	TIMBER FRAMED, HOLLOW CORE CAVITY SLIDING	2040	820	0	2040
120	SELF CLOSING SOLID CORE FIRE DOOR TO NCC (-/60/30)	2100	920		2100 22		SELF CLOSING SOLID CORE FIRE DOOR TO NCC (-/60/30)	2100	920	0	2100
121	TIMBER FRAMED, HOLLOW CORE CAVITY SLIDING SELF CLOSING SOLID CORE FIRE DOOR TO NCC (-/60/30)	2040	920		2040 22	27 28	TIMBER FRAMED, HOLLOW CORE CAVITY SLIDING SELF CLOSING SOLID CORE FIRE DOOR TO NCC (-/60/30)	2040	820	0	2040
122	TIMBER FRAMED, HOLLOW CORE CAVITY SLIDING	2040	920 820		2100 22 2040 22		TIMBER FRAMED, HOLLOW CORE CAVITY SLIDING	2100	920 820	0	2100
124	SELF CLOSING SOLID CORE FIRE DOOR TO NCC (-/60/30)	2100	920		2100 23		SELF CLOSING SOLID CORE FIRE DOOR TO NCC (-/60/30)	2100	920	0	2100
125	TIMBER FRAMED, HOLLOW CORE CAVITY SLIDING	2040	820		2040 23		TIMBER FRAMED, HOLLOW CORE CAVITY SLIDING	2040	820	0	2040
126	SELF CLOSING SOLID CORE FIRE DOOR TO NCC (-/60/30)	2100	920		2100 23		SELF CLOSING SOLID CORE FIRE DOOR TO NCC (-/60/30)	2100	920	0	2100
127	TIMBER FRAMED, HOLLOW CORE CAVITY SLIDING	2040	820	0 2	2040 23	33	TIMBER FRAMED, HOLLOW CORE CAVITY SLIDING	2040	820	0	2040
128	SELF CLOSING SOLID CORE FIRE DOOR TO NCC (-/60/30)	2100	920	0 2	2100 23	34	SELF CLOSING SOLID CORE FIRE DOOR TO NCC (-/60/30)	2100	920	0	2100
129	TIMBER FRAMED, HOLLOW CORE CAVITY SLIDING	2040	820		2040 23		TIMBER FRAMED, HOLLOW CORE CAVITY SLIDING	2040	820	0	2040
130	SELF CLOSING SOLID CORE FIRE DOOR TO NCC (-/60/30)	2100	920		2100 23		SELF CLOSING SOLID CORE FIRE DOOR TO NCC (-/60/30)	2100	920	0	2100
131	TIMBER FRAMED, HOLLOW CORE CAVITY SLIDING	2040	820		2040 23		TIMBER FRAMED, HOLLOW CORE CAVITY SLIDING	2040	820	0	2040
132 133	SELF CLOSING SOLID CORE FIRE DOOR TO NCC (-/60/30) TIMBER FRAMED, HOLLOW CORE CAVITY SLIDING	2100 2040	920		2100 23 2040 23		SELF CLOSING SOLID CORE FIRE DOOR TO NCC (-/60/30) TIMBER FRAMED, HOLLOW CORE CAVITY SLIDING	2100	920	0	2100
133	SELF CLOSING SOLID CORE FIRE DOOR TO NCC (-/60/30)	2040	920	-	2040 23 2100 24		SELF CLOSING SOLID CORE FIRE DOOR TO NCC (-/60/30)	2040	920	0	2040
135	TIMBER FRAMED, HOLLOW CORE CAVITY SLIDING	2040	820		2040 24		TIMBER FRAMED, HOLLOW CORE CAVITY SLIDING	2040	820	0	2040
136	SELF CLOSING SOLID CORE FIRE DOOR TO NCC (-/60/30)	2100	920		2100 24		SELF CLOSING SOLID CORE FIRE DOOR TO NCC (-/60/30)	2100	920	0	2100
137	TIMBER FRAMED, HOLLOW CORE CAVITY SLIDING	2040	820	0 2	2040 24	43	TIMBER FRAMED, HOLLOW CORE CAVITY SLIDING	2040	820	0	2040
138	SELF CLOSING SOLID CORE FIRE DOOR TO NCC (-/60/30)	2100	920	0 2	2100 24		SELF CLOSING SOLID CORE FIRE DOOR TO NCC (-/60/30)	2100	920	0	2100
139	TIMBER FRAMED, HOLLOW CORE CAVITY SLIDING	2040	820		2040 24		TIMBER FRAMED, HOLLOW CORE CAVITY SLIDING	2040	820	0	2040
140	SELF CLOSING SOLID CORE FIRE DOOR TO NCC (-/60/30)	2100	920		2100 24		SELF CLOSING SOLID CORE FIRE DOOR TO NCC (-/60/30)	2100	920	0	2100
141	TIMBER FRAMED, HOLLOW CORE CAVITY SLIDING	2040	820	-	2040 24		TIMBER FRAMED, HOLLOW CORE CAVITY SLIDING	2040	820		
142 143	SELF CLOSING SOLID CORE FIRE DOOR TO NCC (-/60/30) TIMBER FRAMED, HOLLOW CORE CAVITY SLIDING	2100 2040	920 820		2100 30 2040 30	01 02	SELF CLOSING SOLID CORE FIRE DOOR TO NCC (-/60/30) SELF CLOSING SOLID CORE FIRE DOOR TO NCC (-/60/30)	2100	920 C	)EVELCOPMENT	APPELICATION
143	SELF CLOSING SOLID CORE FIRE DOOR TO NCC (-/60/30)	2100	920		2100	-		12100	0=0	NOT FOR CON	
									Ľ	NUT FUR CUP	

DRAWING	AMENDMENTS		BRADLEY ST REDEVELOPMENT		DRAWING TITLE	DOOR SCHEDULE
REVISION	DESCRIPTION DEVELOPMENT APPLICATION	DATE 06/12/2024	CLIENT YARRABEE PROPERTY GROUP PTY LTD	ARCHITECTS residential commercial industrial P: 02 4822 5934 ABN: 71425067537		LOT 16 DP 1084067
		Builder	Figured dimensions take precedence. Do not scale drawings. Builder to check all levels datum and dimensions on the job, conflicting information to be resolved by the project manager prior to commencing work. All materials and workmanship to be in restrict accordance with current Australian standards, BCA, Local regulation	ROSS PLACE GOULBURN NSW 2580 NOMINATED ARCHITECT:		
			and manufacturers current printed instructions. Unless noted otherwise use only best quality materials, fittings and fixtures. COPYRIGHT TIM LEE ARCHITECTS Drawings subject to copyright and may not be reproduced in any form without the written permission of the architect.	NSW REG: 7304 ACT REG: 1030	STREET ADDRESS	61 & 63 BRADLEY STREET GOULBUF

	DRAWING COMMENCED	DRAWING VERIFIED BY
	07/24	TL
	DRAWING SCALE	DRAWN BY
		AH
	AT SHEET SIZE	JOB NUMBER
	A3 SHEET	0624-1688
	DRAWING IDENTIFICATION NUMBER	AMENDMENT ISSUE
URN	A-26	А


	WINDOW SCHEDULE					WINDOW SCHEDULE						
VINDOW NO.	WINDOW TYPE	HEIGHT	WIDTH	SILL HEIGHT	HEAD HEIGHT	WINDOW NO.	WINDOW TYPE	HEIGHT	WIDTH	SILL HEIGHT	HEAD HEIGH	
1	ALUMINIUM FRAMED WINDOWS, POWDERCOAT FINISH WITH MATCHING FLYSCREENS	1800	2710	300	2100	112	ALUMINIUM FRAMED WINDOWS, POWDERCOAT FINISH WITH MATCHING FLYSCREENS	1500	1510	600	2100	
2	ALUMINIUM FRAMED SKYLIGHT, REFER TO THE NATHERS/BASIX SPECIFICATION	1200	798			113	ALUMINIUM FRAMED WINDOWS, POWDERCOAT FINISH WITH MATCHING FLYSCREENS	1500	1510	600	2100	
3	ALUMINIUM FRAMED SKYLIGHT, REFER TO THE NATHERS/BASIX SPECIFICATION	1200	798			114	ALUMINIUM FRAMED WINDOWS, POWDERCOAT FINISH WITH MATCHING FLYSCREENS	1500	1510	600	2100	
4	ALUMINIUM FRAMED SKYLIGHT, REFER TO THE NATHERS/BASIX SPECIFICATION	1200	798			115	ALUMINIUM FRAMED WINDOWS, POWDERCOAT FINISH WITH MATCHING FLYSCREENS	1500	1510	600	2100	
5	ALUMINIUM FRAMED SKYLIGHT, REFER TO THE NATHERS/BASIX SPECIFICATION	1200	798			201	ALUMINIUM FRAMED WINDOWS, POWDERCOAT FINISH WITH MATCHING FLYSCREENS	1500	1510	600	2100	
6	ALUMINIUM FRAMED SKYLIGHT, REFER TO THE NATHERS/BASIX SPECIFICATION	1200	798			202	ALUMINIUM FRAMED WINDOWS, POWDERCOAT FINISH WITH MATCHING FLYSCREENS	1500	1510	600	2100	
01	ALUMINIUM FRAMED WINDOWS, POWDERCOAT FINISH WITH MATCHING FLYSCREENS	1500	1510	600	2100	203	ALUMINIUM FRAMED WINDOWS, POWDERCOAT FINISH WITH MATCHING FLYSCREENS	1500	1510	600	2100	
02	ALUMINIUM FRAMED WINDOWS, POWDERCOAT FINISH WITH MATCHING FLYSCREENS	1500	1510	600	2100	204	ALUMINIUM FRAMED WINDOWS, POWDERCOAT FINISH WITH MATCHING FLYSCREENS	1500	1510	600	2100	
03	ALUMINIUM FRAMED WINDOWS, POWDERCOAT FINISH WITH MATCHING FLYSCREENS	1500	1510	600	2100	205	ALUMINIUM FRAMED WINDOWS, POWDERCOAT FINISH WITH MATCHING FLYSCREENS	1500	1510	600	2100	
04	ALUMINIUM FRAMED WINDOWS, POWDERCOAT FINISH WITH MATCHING FLYSCREENS	1500	1510	600	2100	206	ALUMINIUM FRAMED WINDOWS, POWDERCOAT FINISH WITH MATCHING FLYSCREENS	1500	1510	600	2100	
05	ALUMINIUM FRAMED WINDOWS, POWDERCOAT FINISH WITH MATCHING FLYSCREENS	1500	1510	600	2100	207	ALUMINIUM FRAMED WINDOWS, POWDERCOAT FINISH WITH MATCHING FLYSCREENS	1500	1510	600	2100	
06	ALUMINIUM FRAMED WINDOWS, POWDERCOAT FINISH WITH MATCHING FLYSCREENS	1500	1510	600	2100	208	ALUMINIUM FRAMED WINDOWS, POWDERCOAT FINISH WITH MATCHING FLYSCREENS	1500	1510	600	2100	
07	ALUMINIUM FRAMED WINDOWS, POWDERCOAT FINISH WITH MATCHING FLYSCREENS	1500	1510	600	2100	209	ALUMINIUM FRAMED WINDOWS, POWDERCOAT FINISH WITH MATCHING FLYSCREENS	1500	1510	600	2100	
80	ALUMINIUM FRAMED WINDOWS, POWDERCOAT FINISH WITH MATCHING FLYSCREENS	1500	1510	600	2100	210	ALUMINIUM FRAMED WINDOWS, POWDERCOAT FINISH WITH MATCHING FLYSCREENS	1500	1510	600	2100	
)9	ALUMINIUM FRAMED WINDOWS, POWDERCOAT FINISH WITH MATCHING FLYSCREENS	1500	1510	600	2100	211	ALUMINIUM FRAMED WINDOWS, POWDERCOAT FINISH WITH MATCHING FLYSCREENS	1500	1510	600	2100	
0	ALUMINIUM FRAMED WINDOWS, POWDERCOAT FINISH WITH MATCHING FLYSCREENS	1500	1510	600	2100	212	ALUMINIUM FRAMED WINDOWS, POWDERCOAT FINISH WITH MATCHING FLYSCREENS	1500	1510	600	2100	
11	ALUMINIUM FRAMED WINDOWS, POWDERCOAT FINISH WITH MATCHING FLYSCREENS	1500	1510	600	2100	213	ALUMINIUM FRAMED WINDOWS, POWDERCOAT FINISH WITH MATCHING FLYSCREENS	1500	1510	600	2100	
						214	ALUMINIUM FRAMED WINDOWS, POWDERCOAT FINISH WITH MATCHING FLYSCREENS	1500	1510	600	2100	
						215	ALUMINIUM FRAMED WINDOWS, POWDERCOAT FINISH WITH MATCHING FLYSCREENS	1500	1510	600	2100	

DRAWING AMENDMENTS			BRADLEY ST REDEVELOPMENT		DRAWING TITLE	WINDOW SCHEDULE
REVISION	A DESCRIPTION DATE 06/12/2024		CLIENT YARRABEE PROPERTY GROUP PTY LTD	ARCHITECTS residential commercial industrial P: 02 4822 5934 ABN: 71425067537		LOT 16 DP 1084067
		Figured dimensions take precedence. Do not scale drawings. Builder to check all levels datum and dimensions on the job, conflicting information to be resolved by the project manager prio commencing work. All materials and workmanship to be in restrict accordance with current Australian standards, BCA, Local reg		ROSS PLACE GOULBURN NSW 2580 NOMINATED ARCHITECT:		LOT 10 DF 1084007
			and manufacturers current printed instructions. Unless noted otherwise use only best quality materials, fittings and fixtures. COPYRIGHT TIM LEE ARCHITECTS Drawings subject to copyright and may not be reproduced in any form without the written permission of the architect.	TIM LEE NSW REG: 7304 ACT REG: 1030	STREET ADDRESS	61 & 63 BRADLEY STREET GOULBU

ISSUED FOR\_\_\_\_\_ NOT FOR CONSTRUCTION DRAWING COMMENCED DRAWING VERIFIED BY 07/24 ΤL DRAWING SCALE DRAWN BY AH AT SHEET SIZE JOB NUMBER A3 SHEET 0624-1688 DRAWING IDENTIFICATION NUMBER AMENDMENT ISSUE URN A-27 А



RAWING VERIFIED BY T.L. AH 0624-1688 А

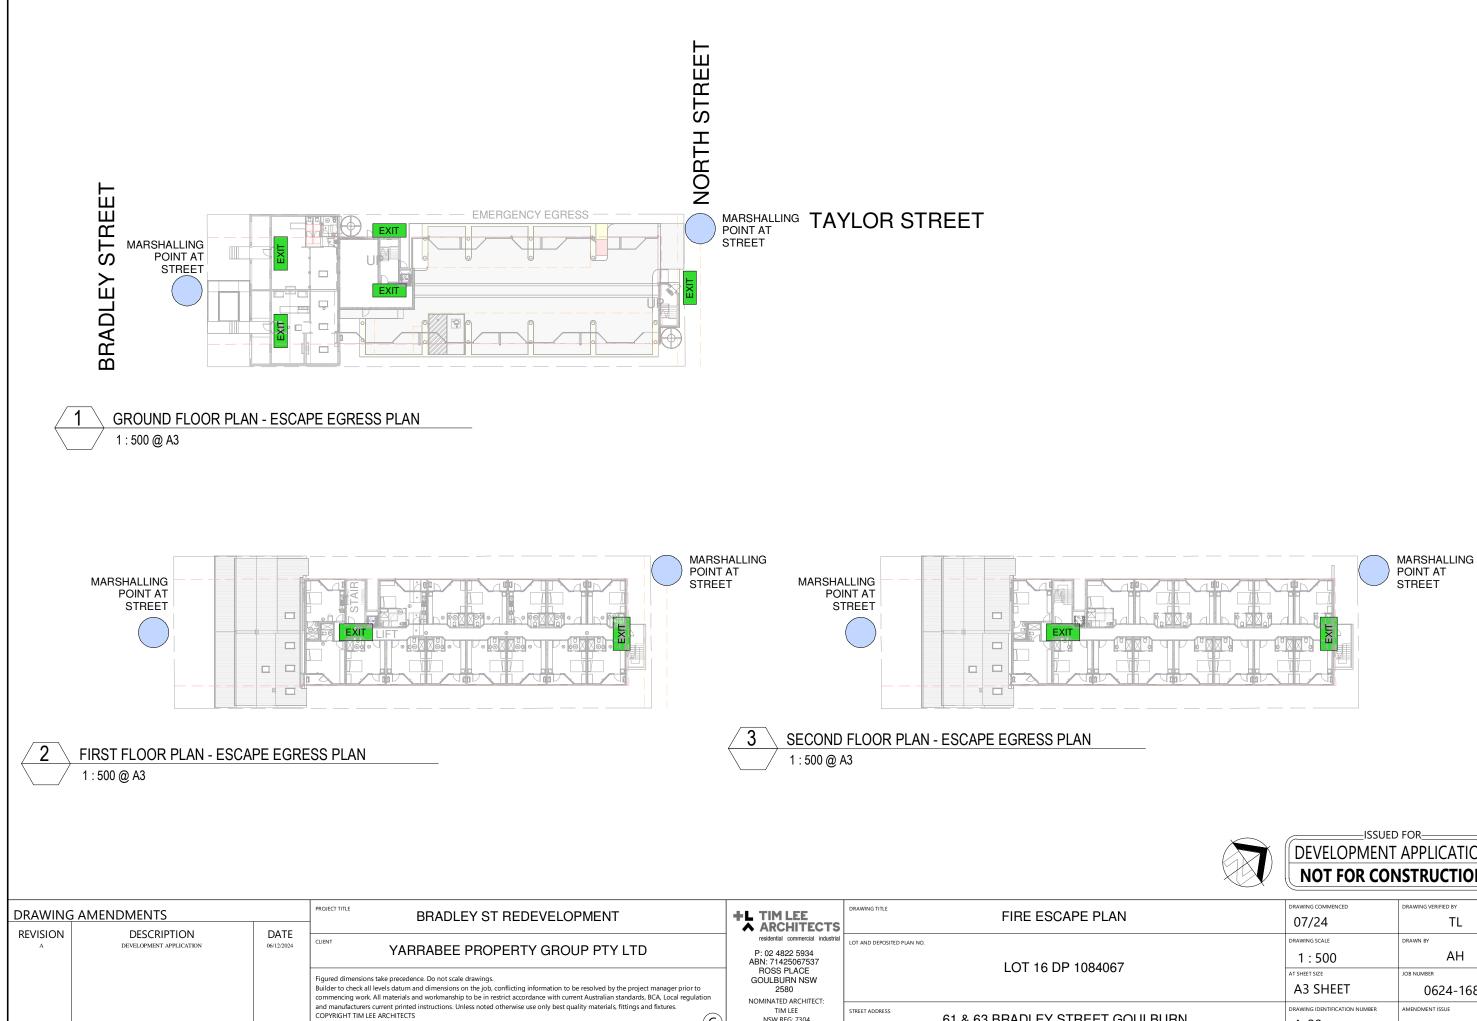


(C)

Drawings subject to copyright and may not be reproduced in any form without the written permission of the architec

NSW REG: 7304

ACT REG: 1030

	DEVELOPMENT	APPLICATION
FIRE ESCAPE PLAN	drawing commenced 07/24	drawing verified by
LOT 16 DP 1084067	DRAWING SCALE 1:500 AT SHEET SIZE A3 SHEET	DRAWN BY AH JOB NUMBER 0624-1688
61 & 63 BRADLEY STREET GOULBURN	DRAWING IDENTIFICATION NUMBER	AMENDMENT ISSUE

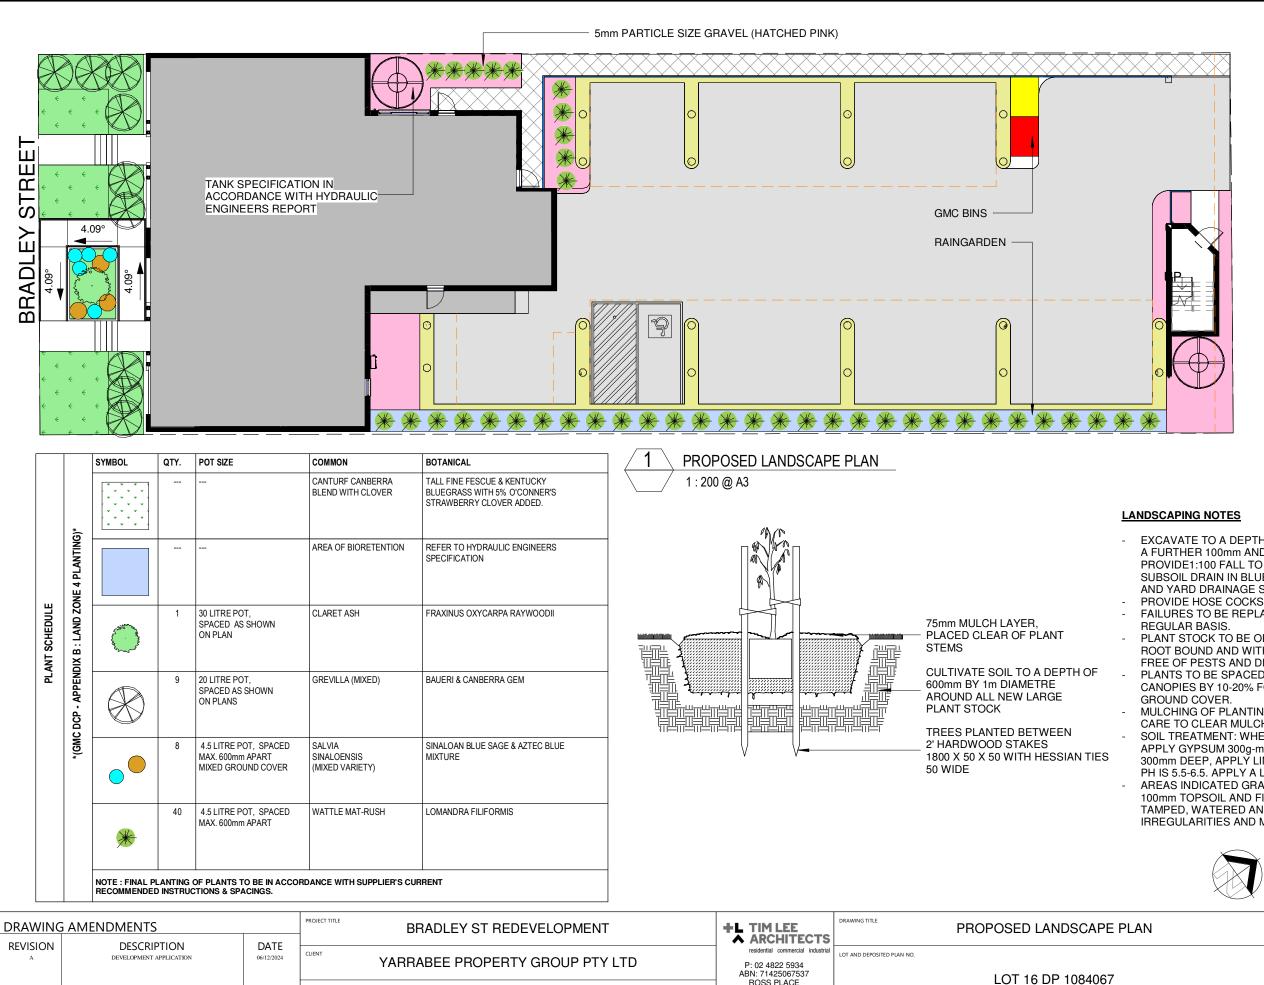

Figured dimensions take precedence. Do not scale drawings

COPYRIGHT TIM LEE ARCHITECTS

Builder to check all levels datum and dimensions on the job, conflicting information to be resolved by the project manager prior to

and manufacturers current printed instructions. Unless noted otherwise use only best quality materials, fittings and fixtures.

Drawings subject to copyright and may not be reproduced in any form without the written permission of the architect

commencing work. All materials and workmanship to be in restrict accordance with current Australian standards, BCA, Local regulation

ROSS PLACE

GOULBURN NSW

2580

NOMINATED ARCHITECT

NSW REG: 7304

ACT REG: 1030

(C)

TIM LEE

STREET ADDRESS

# **NOTES**

# **RAINGARDEN DESIGN TO HYDRAULIC** ENGINEERS DETAILS.

PLANT SPECIES TO BE SELECTED FROM GOULBURN MULWAREE COUNCIL'S DEVELOPMENT CONTROL PLAN APPENDIX B, PREFERRED PLANING SPECIES IN THE GOULBURN MULWAREE GOVERNMENT AREA. FINAL PLANT SELECTION BY CLIENT.

IF A SUB-SOIL WATERING SYSTEM IS INSTALLED, CONNECT TO RAIN WATER TANKS WITH TIMER. DRIPPERS TO BE PLACED AT EACH PLANT BASE. INSTALL TO MANUFACTURER'S CURRENT PRINTED INSTRUCTIONS.

THE CONTRACTOR IS TO NOTIFY THE PROJECT MANAGER IS ANY ERRORS OR OMISSIONS IN THE DOCUMENTATION PRIOR TO COMMENCING WORK. THE PROJECT MANAGER TO CONTACT THE APPROPRIATE CONSULTANT FOR ADVICE PRIOR TO COMMENCING THE WORKS.

ALL FLOOR LEVELS & GROUND LEVELS ARE ASSUMED & TO BE CONFIRMED ONSITE, PRIOR TO COMMENCING ANY WORKS.

NOTE : FINAL PLANTING OF PLANTS TO BE IN ACCORDANCE WITH SUPPLIER'S CURRENT **RECOMMENDED INSTRUCTIONS &** SPACINGS.

EXCAVATE TO A DEPTH OF 300mm, BREAK UP SUBGRADE A FURTHER 100mm AND BACKFILL WITH TOPSOIL MIXTURE. PROVIDE1:100 FALL TO BASE OF BED WITH 100 PVC SUBSOIL DRAIN IN BLUE METAL CONNECTED TO ROOF AND YARD DRAINAGE SYSTEM.

PROVIDE HOSE COCKS FOR WATERING AT 30cm CENTRES FAILURES TO BE REPLACED AND WEEDS REMOVED ON

PLANT STOCK TO BE OF GOOD QUALITY, HARDENED OFF, NOT ROOT BOUND AND WITH A LEADING SHOOT IF A TREE SPECIES. FREE OF PESTS AND DISEASE.

PLANTS TO BE SPACED TO ENSURE INTERLOCKING OF CANOPIES BY 10-20% FOR SHRUBS AND 30-40% FOR

MULCHING OF PLANTING BED TO BE 75mm THICK TAKING CARE TO CLEAR MULCH FROM STEMS.

SOIL TREATMENT: WHERE TOP SOIL HAS BEEN STRIPPED, APPLY GYPSUM 300g-m sq. AFTER REPLACING TOPSOIL TO 300mm DEEP, APPLY LIME AT 200g/m sg. AND ENSURE PH IS 5.5-6.5. APPLY A LOW 9NKPS FERTILISER AT 100g/m sq> AREAS INDICATED GRASSED TO BE ROTARY HOED THROUGH 100mm TOPSOIL AND FIRST QUALITY TURF TO BE ROLLED, TAMPED, WATERED AND TOP DRESSED. REMOVE IRREGULARITIES AND MOW AT FORTNIGHTLY INTERVALS.

-ISSUED FOR

)	DEVELOPMENT NOT FOR CON		)
	DRAWING COMMENCED	DRAWING VERIFIED BY	

PROPOSED LANDSCAPE PLAN LOT 16 DP 1084067	drawing commenced 07/24	drawing verified by
	DT/24	
	As indicated	AH
	AT SHEET SIZE A3 SHEET	JOB NUMBER 0624-1688
61 & 63 BRADLEY STREET GOULBURN	DRAWING IDENTIFICATION NUMBER	